GENERAL NOTES:

- 1. ALL WORK SHALL CONFORM TO THE 2020 BUILDING CODE OF NEW YORK STATE CURRENT EDITION AND ALL LOCAL / MUNICIPAL CODES.
- 2. ALL WORK INCLUDING MATERIAL STRESSES AND METHODS OF CONSTRUCTION, SHALL CONFORM TO LOCAL AND STATE CODES.
- 3. CONTRACTOR SHALL CHECK AND VERIFY ALL EXISTING CONDITIONS AND CHECK ALL DIMENSIONS OF THE PROPOSED NEW CONSTRUCTION IN THE FIELD BEFORE STARTING WORK AND REPORT ANY DISCREPANCIES TO THE ARCHITECT PRIOR TO THE START OF WORK.
- 4. INDEMNIFICATION: THE CONTRACTOR AND HIS SUBCONTRACTORS SHALL INDEMNIFY AND SAVE HARMLESS THE OWNER, THE OWNER'S ARCHITECT / ENGINEER, THEIR OFFICERS, AGENTS AND EMPLOYEES FROM ALL LOSSES, COSTS, FEES, EXPENSES, DAMAGES, OR LIABILITIES CAUSE OF 1- BODILY INJURY (INCLUDING DEATH), ACTUAL OR ALLEGED, TO ANY PERSON (INCLUDING BUT NOT LIMITED TO ANY EMPLOYEE OF THE OWNER OR THE CONTRACTOR OR HIS SUBCONTRACTOR AND INCLUDING ANY THIRD PARTY), OR 2- DAMAGE TO PROPERTY (INCLUDING BUT NOT LIMITED TO THE PROPERTY OF THE OWNER OR IT'S EMPLOYEES OR OF THE CONTRACTOR AND HIS SUBCONTRACTORS OR IT'S EMPLOYEES, OR OF ANY SUBCONTRACTOR OF THE CONTRACTOR AND INCLUDING THE PROPERTY OF ANY THIRD PARTY), ACTUAL OR ALLEGED, IF SUCH BODILY INJURY OR PROPERTY DAMAGE RESULTS DIRECTLY OR INDIRECTLY FROM THE PERFORMANCE OF THIS CONTRACT AND WHETHER OR NOT SUCH BODILY INJURY OR PROPERTY DAMAGE IS CAUSED BY THE ACTS OR OMISSIONS, NEGLIGENT OR OTHERWISE, OF THE CONTRACTOR AND AGENTS OR EMPLOYEES OR OF ANY SUBCONTRACTORS OF THE CONTRACTOR AND HIS SUBCONTRACTORS, OR OF THE OWNER, ITS OFFICERS, AGENTS, OR EMPLOYEES.
- 5. ALL MATERIALS, ASSEMBLIES, FORMS AND METHODS OF CONSTRUCTION AND SERVICES EQUIPMENT SHALL MEET THE FOLLOWING REQUIREMENTS. A. ACCEPTABLE PRIOR TO THE EFFECTIVE DATE OF THE CODE BY THE BOARD B. ACCEPTED FOR USE UNDER PRESCRIBED CODE TEST METHODS.
- 6. GENERAL CONTRACTOR SHALL COORDINATE HIS/HER WORK WITH THAT OF OTHER SUBCONTRACTORS AND SUPPLIERS.
- 7. CONTRACTOR SHALL PATCH AND REPAIR ALL SURFACES OPENED DURING THE INSTALLATION OF THE WORK AND REPAIR ALL EXISTING AREAS THAT REMAIN DAMAGED DURING THE PERFORMANCE OF THE WORK.
- 8. ALL DRAWINGS, SPECIFICATIONS AND CONSTRUCTION NOTES ARE COMPLEMENTARY, AND WHAT IS CALLED FOR BY ONE WILL BE BINDING AS IF CALLED FOR BY ALL; ANY WORK SHOWN OR REFERRED TO ON ANY DOCUMENT SHALL BE PROVIDED AS THOUGH SHOWN ON ALL DOCUMENTS.
- 9. THE CHARACTER AND SCOPE OF WORK ARE ILLUSTRATED BY THE DRAWINGS. TO INTERPRET AND EXPLAIN THE DRAWINGS, OTHER INFORMATION DEEMED NECESSARY BY THE ARCHITECT WILL BE FURNISHED TO THE CONTRACTOR WHEN AND AS REQUIRED BY THE WORK, AND IT IS TO BE UNDERSTOOD THAT THE SAID ADDITIONAL DRAWINGS ARE TO BE OF EQUAL FORCE WITH THE DRAWINGS AND SHALL BE CONSIDERED AS FORMING PART OF THESE NOTES TO WHICH THEY REFER.
- 10. CONTRACTOR SHALL NOT OBSTRUCT ACCESS TO ROADWAYS AT ANY TIME.
- 11. ALL DIMENSIONS NOTED ON PLANS ARE TO ROUGH FRAMING UNLESS OTHERWISE NOTED.
- 12. CONTRACTOR SHALL REPORT ANY DISCREPANCIES BETWEEN THIS DOCUMENT AND CONTRACT DOCUMENTS ISSUED TO OTHERS PRIOR TO THE START OF THE WORK.
- 13. CONTRACTOR SHALL COMPLY WITH ALL REQUIREMENTS OF THE NEW YORK STATE BUILDING CODES, STATE LABOR LAW AND ALL REGULATIONS OF NEW YORK STATE AND OTHER GOVERNMENT AGENCIES. ALL PERMITS SHALL BE PROPERLY DISPLAYED.
- 14. PENETRATION IN OPENINGS OF WALL PARTITIONS OR FLOORS FOR PIPE SLEEVES, ELECTRICAL DEVICES, ETC. SHALL BE PACKED AND SEALED OR OTHERWISE ISOLATED TO MAINTAIN THE REQUIRED FIRE STOPPING AND SOUND TRANSMISSION CLASSIFICATION RATING.
- 15. ALL ELECTRICAL WORK SHALL BE DONE IN ACCORDANCE WITH ANY AND ALL APPLICABLE CODES.
- 16. ALL PLUMBING & HVAC WORK SHALL BE DONE IN ACCORDANCE WITH ANY AND ALL APPLICABLE CODES.
- 17. MECHANICAL DESIGN-BUILD SHALL BE BY OTHERS.
- 18. IF, IN THE INTERPRETATION OF CONTRACT DOCUMENTS, REQUIREMENTS WITHIN THE DRAWINGS AND SPECIFICATIONS CONFLICT, OR IT APPEARS THAT THE DRAWINGS AND SPECIFICATIONS ARE NOT IN AGREEMENT, THE REQUIREMENT TO BE FOLLOWED SHALL BE DECIDED BY THE ARCHITECT. WHERE THERE IS A DISCREPANCY IN THE QUANTITY, THE CONTRACTOR SHALL PROVIDE THE GREATER QUANTITY; WHERE THERE IS A DISCREPANCY IN THE QUALITY, THE CONTRACTOR SHALL PROVIDE THE SUPERIOR QUALITY.
- 19. THE CONTRACTOR IS RESPONSIBLE FOR FURNISHING AND INSTALLING ALL COMPONENTS, ACCESSORIES, ETC. FOR A COMPLETE PROJECT INCLUDING ITEMS NOT SHOWN IN THESE CONSTRUCTION DRAWINGS.

20. ALL PRODUCTS ARE TO BE INSTALLED IN STRICT CONFORMANCE W/ MANUFACTURER'S INSTALLATION INSTRUCTIONS. NO EXCEPTIONS.

RENOVATIONS FOR:

LDD PROPERTIES 18 CHURCH STREET FISHKILL, NY 12524

ABBREVIATIONS

CLG CLO CLR CMU COL CONC CONF CONT CONTR CORR CSMU CT

ELEVATION

EMERGENCY

EQUIPMENT EGRESS UNIT

EXTERIOR

EXPANSION JOINT

ELECTRIC WATER COOLER

EXISTING WINDOW OPENING

EMO EXISTING EQUAL EQUAL EQUIP EQUIPMEN.
E.U. EGRESS U
EWC ELECTRIC
EWO EXISTING V
EXHIB EXHIBIT
EXIST/EXIST'G EXISTING

	ACOUSTICAL CEILING TILE	FE	FIRE EXTINGUISHER WALL MTD.	NC	NONCOMBUSTIBLE	Т	TREAD
	ADDENDUM	FD	FLOOR DRAIN	NIC		T/	TOP OF
					NOT IN CONTRACT		
	ADJACENT	FIN	FINISH	NO	NUMBER	T&G	TONGUE AND GROOVE
	ABOVE FINISHED FLOOR	FIX	FIXTURE	NOM	NOMINAL	T/S	TOP OF STEEL
	ALTERNATE	FL	FLOOR	NTS	NOT TO SCALE	TB	TACK BOARD
	ALUMINUM	FND	FEMININE NAPKIN DISPOSAL			TCB	TECTUM BOARD
	ANODIZED FINISH	FNDN	FOUNDATION	OC	ON CENTER	TEL	TELEPHONE
	ACOUSTICAL PANEL	FNV	FEMININE NAPKIN VENDOR	OH	OVERHEAD	TEMP	TEMPERED
,	APPROXIMATE	FRP		OPNG	OPENING	TERR	TERRAZZO
			FIBER REINFORCED PLASTIC				
	ARCHITECT/ARCHITECTURAL	FT	FEET	OPP HD	OPPOSITE HAND	TG	TEMPERED GLASS
	ASSOCIATED	FTG	FOOTING			THK	THICK
	AUDIO VISUAL	FURN	FURNISH / FURNITURE	PART	PARTITION	THRU	THROUGH
		FUR	FURRED / FURRING	PC	PLUMBING CONTRACTOR	TOC	TOP OF CONCRETE
	BULLETIN BOARD	FR	FIRE RESISTANT	PF	PRE-FINISHED	TOF	TOP OF FOOTING
	BOTTOM OF	FEC	FIRE EXTINGUISHER CABINET	PL	PLATE	TOM	TOP OF MASONRY
		120	THE EXTINGUISHER ONBINE	PL LAM/PLAS LAM	PLASTIC LAMINATE	TPH	TOILET PAPER HOLER
	BUILDING					TS	TACK STRIP
	BLOCKING	GA	GUAGE	PLAST	PLASTER		
	BEAM/BEAMS	GAL	GALLON	PLMBG	PLUMBING	TYP	TYPICAL
	BOTTOM OF SOFFIT	GALV	GALVANIZED	PLY/PLYWD	PLYWOOD		
	BOARD	GB	GRAB BAR	PNL	PANEL	UG	UNDERGROUND
	BEARING		= 1	P/PNT	PAINT		
	BASEMENT	GC_	GENERAL CONTRACT	POL	POLISH	UH	UNIT HEATER
	DASEIVIEINI	GCT	GRANITE COUNTER TOP	PR	PAIR	UL	UNDERWRITERS LABATORIES
		GL	GLASS / GLAZING	PT	POINT	UNO/UON	UNLESS OTHERWISE NOTED
	CARPET	GND	GROUND	PTD		U/S	UNDERSIDE
	CABINET	GYP WALL BD/GWB	GYPSUM WALL BOARD		PAPER TOWEL DISPENSER	UTIL	UTILITY
		G	G. 1. GG. 11. 11. 122 2 G. 11. 12	PTN	PARTITION	ŪV	UNIT ELEVATOR
	CHALKBOARD			PVC	POLY VINYL CHLORIDE	•	Oran ELE Victori
	CONTROL JOINT			PGB	PAINTED GYPSUM BOARD		
	CENTER LINE	Н	HIGH	PS	PROJECTION SCREEN	V	VINYL
	CEILING	H/C	DISABLED ACCESS			VCT	VINYL COMPOSIT TILE
	CLOSET	HD	HEAVY DUTY			VET	VERTICAL
	COOLER	HDR	HEADER	Q.T.	QUARRY TILE	VIF	VERIFY IN FIELD
	CONCRETE MASONRY UNIT	HDWR	HARDWARE			VTR	VENT THROUGH ROOF
	COLUMN	HM	HOLLOW METAL	R	RISER	V 111	VENT THROOGITHOO!
		HORZ	HORIZONTAL	RAD	RADIUS		
	CONCRETE					W	WIDE
	CONFERENCE	HR	HANDRAIL / HOUR	RCP	REFLECTED CEILING PLAN	W/	WITH
	CONTINUOUS	HT	HEIGHT	RD	ROOF DRAIN		
	CONTRACTOR	HTG	HEATING	RE	REFER TO	WB	WHITEBOARD
	CORRIDOR	HVAC	HEATING VENTILATION A/C	REFRIG	REFRIGERATOR	WC	WATER CLOSET
	CALCIUM SILICATE MASONRY UNIT			REQD	REQUIRED	WD	WOOD
	CERAMIC TILE			RH	RIGHT HAND	WP	WATERPROOF
	CERAMIC TILE BASE	ID	INSIDE DIAMETER	RHR	RIGHT HAND REVERSE	WR GWB	WATER RESISTANT GYPSUM BI
	OLITAWIO TILL DAGE	INSUL	INSULATION	RM	ROOM		
		INV	INVERT	LINI	HOOIVI		
	DOLIDI E ACTINO	··					
	DOUBLE ACTING	JAN	JANITOR	S	SEALER		
-	DETAIL	JT	JOINT	SAT	SATURATION		
	DRINKING FOUNTAIN	JI	JOINT	SC	SOLID CORE WOOD DOOR		
	DIAMETER			SD	SOAP DISPENSER		
	DISPENSER	KPL	KICKPLATE	SF	SQUARE FEET		
	DIVISION			SHT	SHEET		
	DOWN	1	LAMINATED OLACO		_		
	DOOR	L	LAMINATED GLASS	SIM	SIMILAR		
	DOWNSPOUT	LAV	LAVATORY	SPEC	SPECIFICATION		
		LF	LINEAR FEET	SPD	SOAP DISH		
	DRAWING	LH	LEFT HAND	SQ	SQUARE		
		LHR	LEFT HAND REVERSE	SST	STAINLESS STEEL		
		LIN	LINEN	STL/ST	STEEL		
	EACH	LLH	LONG LEG HORIZONTAL	STRUCT	STRUCTURAL / STRUCTURE		
	ELECTRIC HAND DRYER	LLV	LONG LEG VERTICAL	SUSP	SUSPENDED		
	EXTERIOR INSULATION FINISH SYSTEM	LVR	LOUVER	SV	SHEET VINYL FLOORING		
	ELEVATION	LVN	LOUVEN	5V	SHEET VINTE FLOORING		

MASONRY MATERIAL MAXIMUM

METAL MEZZANINE

MOULDING

METAL PANEL MOISTURE RESISTANT

MASONRY OPENING

MET/MTL MEZZ MFGR MIN

MOP & BROOM HOLDER

MANUFACTURE / MANUFACTURER

SHEAR WALL

DRAWING LIST

5A2.0

DWG. # DRAWING NAME

1T1.0 TITLE SHEET EXISTING & PROPOSED SITE PLANS 2SP1.0 EXISTING ELEVATION PHOTOS

PROPOSED ELEVATIONS

SYMBOLS

EXISTING CONSTRUCTION TO REMAIN EXISTING CONSTRUCTION TO BE DEMOLISHED NEW CONSTRUCTION


EXTERIOR ELEVATION

be

1 OF # 2/6/25 As indicated **DRAWING NO:**

PROJECT PHASE:

PB

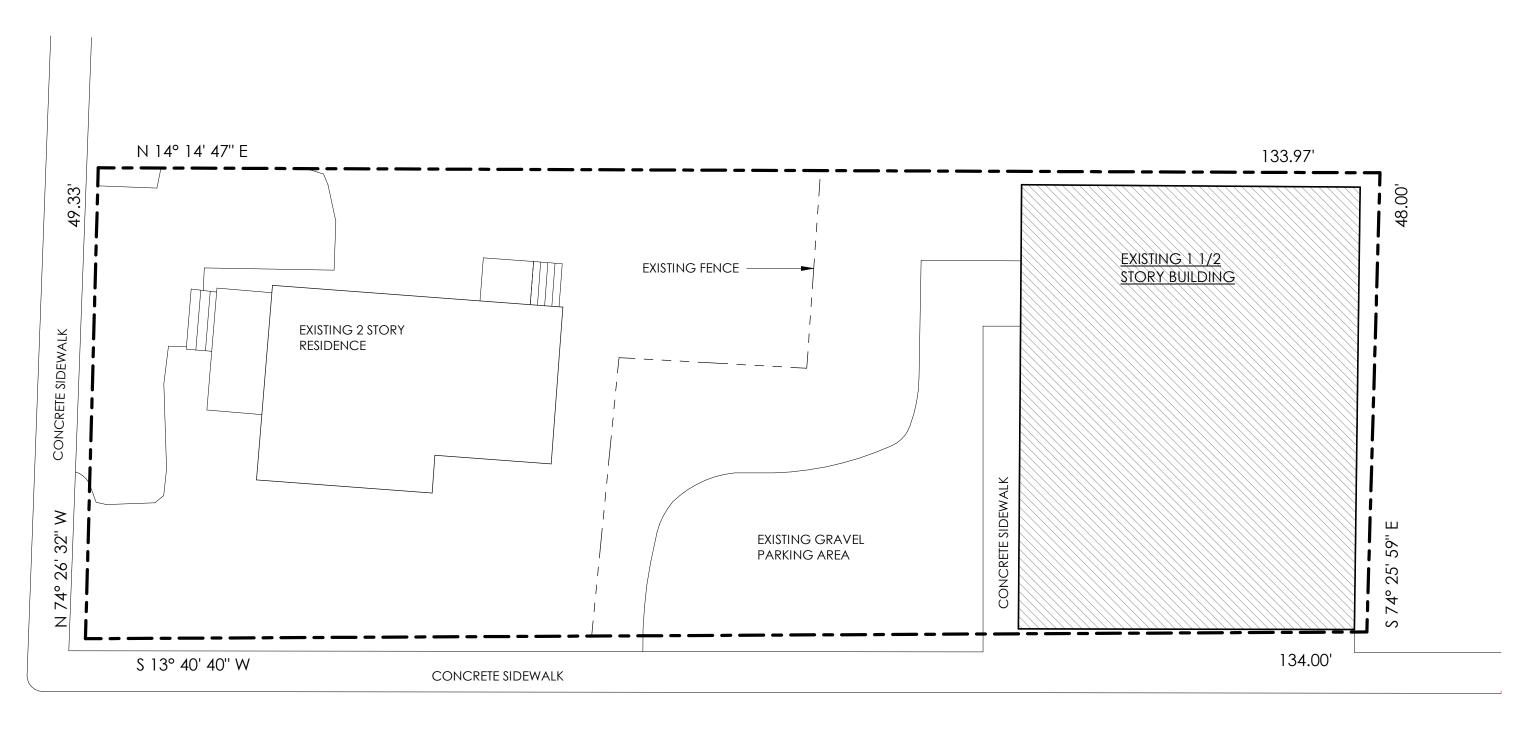


CHURCH STREET

N 1 EXISTING SITE PLAN
2SP1.0 1" = 10'-0"

SURVEY NOTE: ALL SITE PLAN INFORMATION WAS TAKEN FROM A SURVEY AS PREPARED BY:

BADEY & WATSON SURVEYING & ENGINEERING D.P.C. NYS LICENSE No. 49789

DATE OF SURVEY: 1/17/25

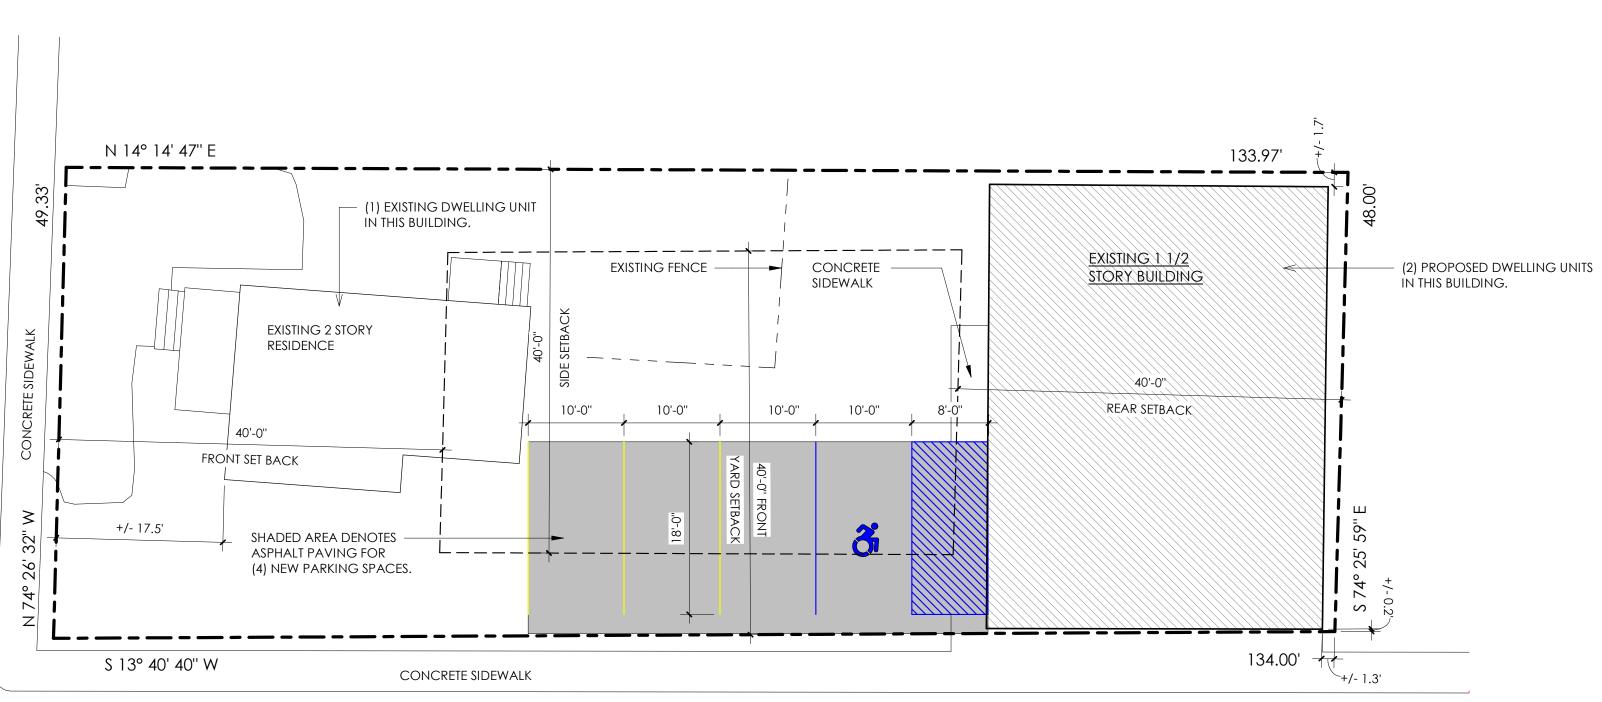

CHURCH STREET


PARKING REQUIREMENTS: 1 FOR EACH DWELLING UNIT PLUS 1/2 FOR EACH BEDROOM. (1) STUDIO + (1) 2-BEDROOM APARTMENT. NUMBER OF SPACES REQUIRED: 4 NUMBER OF SPACES PROVIDED: 4

b: NO SITE PLAN APPROVAL REQUIRED FOR ONE-FAMILY RESIDENCE.

N 2 PROPOSED SITE PLAN
2 2SP1.0 1" = 10'-0"

ZONING INFORMATION TOWNSHIP: TOWN VILLAGE OF FISHKILL, NY SECTION, BLOCK, LOT: 133001-6156-20-824011 ZONE: R-50 MIN. LOT AREA FRONT YD. SIDE YD REAR YD. MAX BLDG. HGHT MAX BLDG. COVERAGE SITE PLAN APPROVAL REQUIRED MIN. WIDTH MIN. DEPTH FRONT YD. 40 FT 30 % YES b ORDINANCE REQUIREMENT: 50,000 SF 150 FT 150 FT 40 FT 40 FT 35 FT 48 FT EXISTING: 6,518 SF +/- 33.6 % 133.97 FT +/- 17.5 FT +/- 0.2 FT +/- 1.7 FT +/- 1.3 FT +/- 18'-6'' NO CHANGE NO CHANGE NO CHANGE NO CHANGE NO CHANGE PROPOSED: NO CHANGE NO CHANGE NO CHANGE +/- 25'-8" NOTES:

Zoning Districts

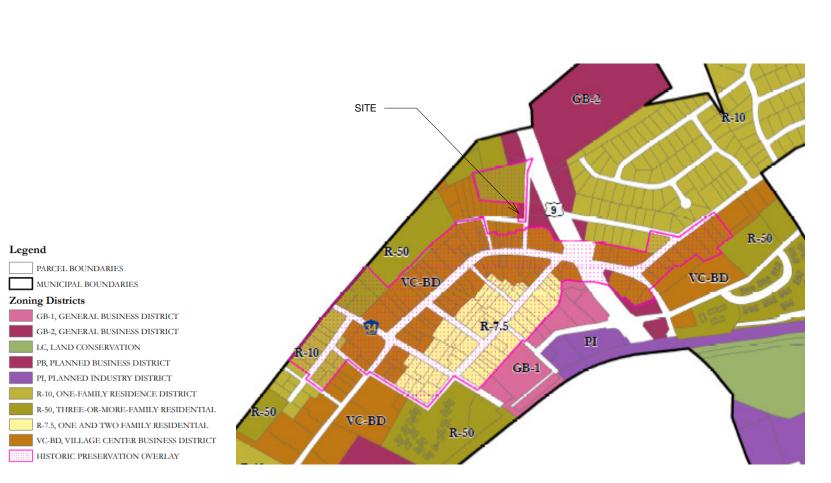





4 LOCATION MAP 2SP1.0 NO SCALE

SW SW

2 OF # DATE: **2/6/25** As indicated

DRAWING NO:

PROJECT PHASE: PB



1 EXISTING FRONT PHOTO 3EP1.0 NO SCALE




3 EXISTING LEFT PHOTO
3EP1.0 NO SCALE



2 EXISTING RIGHT PHOTO
3EP1.0 NO SCALE



4 EXISTING BACK PHOTO
3EP1.0 NO SCALE

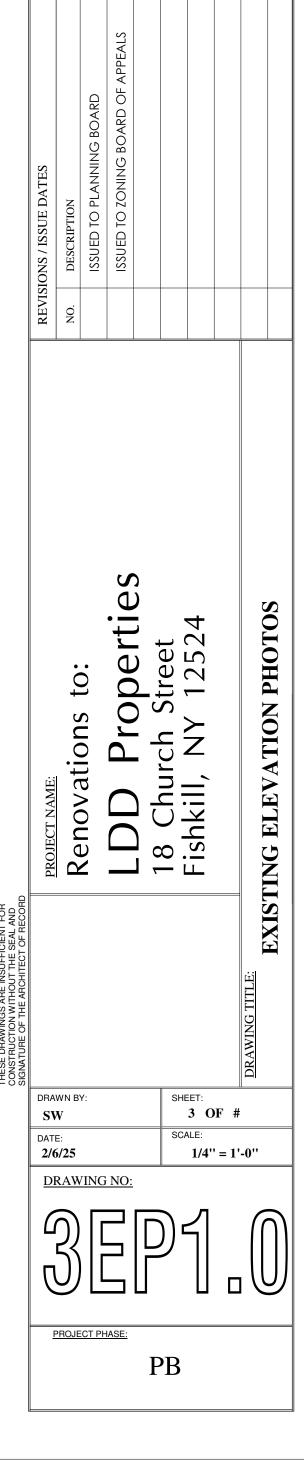



2 LEFT ELEVATION

5A2.0 1/4" = 1'-0"





- BLACK WINDOWS

- BENJAMIN MOORE MANCHESTER TAN HC-81





DRAWN BY:

SW

DATE:
2/6/25 SHEET: 5 OF 5 # 1/4'' = 1'-0'' DRAWING NO: PROJECT PHASE:

PB

