GENERAL NOTES:

- 1. ALL WORK SHALL CONFORM TO THE 2020 BUILDING CODE OF NEW YORK STATE CURRENT EDITION AND ALL LOCAL / MUNICIPAL CODES.
- 2. ALL WORK INCLUDING MATERIAL STRESSES AND METHODS OF CONSTRUCTION, SHALL CONFORM TO LOCAL AND STATE CODES.
- 3. CONTRACTOR SHALL CHECK AND VERIFY ALL EXISTING CONDITIONS AND CHECK ALL DIMENSIONS OF THE PROPOSED NEW CONSTRUCTION IN THE FIELD BEFORE STARTING WORK AND REPORT ANY DISCREPANCIES TO THE ARCHITECT PRIOR TO THE START OF WORK.
- 4. INDEMNIFICATION: THE CONTRACTOR AND HIS SUBCONTRACTORS SHALL INDEMNIFY AND SAVE HARMLESS THE OWNER, THE OWNER'S ARCHITECT / ENGINEER, THEIR OFFICERS, AGENTS AND EMPLOYEES FROM ALL LOSSES, COSTS, FEES, EXPENSES, DAMAGES, OR LIABILITIES CAUSE OF 1-BODILY INJURY (INCLUDING DEATH), ACTUAL OR ALLEGED, TO ANY PERSON (INCLUDING BUT NOT LIMITED TO ANY EMPLOYEE OF THE OWNER OR THE CONTRACTOR OR HIS SUBCONTRACTOR AND INCLUDING ANY THIRD PARTY), OR 2- DAMAGE TO PROPERTY (INCLUDING BUT NOT LIMITED TO THE PROPERTY OF THE OWNER OR IT'S EMPLOYEES OR OF THE CONTRACTOR AND HIS SUBCONTRACTORS OR IT'S EMPLOYEES, OR OF ANY SUBCONTRACTOR OF THE CONTRACTOR AND INCLUDING THE PROPERTY OF ANY THIRD PARTY), ACTUAL OR ALLEGED, IF SUCH BODILY INJURY OR PROPERTY DAMAGE RESULTS DIRECTLY OR INDIRECTLY FROM THE PERFORMANCE OF THIS CONTRACT AND WHETHER OR NOT SUCH BODILY INJURY OR PROPERTY DAMAGE IS CAUSED BY THE ACTS OR OMISSIONS, NEGLIGENT OR OTHERWISE, OF THE CONTRACTOR AND AGENTS OR EMPLOYEES OR OF ANY SUBCONTRACTORS OF THE CONTRACTOR AND HIS SUBCONTRACTORS, OR OF THE OWNER, ITS OFFICERS, AGENTS, OR EMPLOYEES.
- 5. ALL MATERIALS, ASSEMBLIES, FORMS AND METHODS OF CONSTRUCTION AND SERVICES EQUIPMENT SHALL MEET THE FOLLOWING REQUIREMENTS. A. ACCEPTABLE PRIOR TO THE EFFECTIVE DATE OF THE CODE BY THE BOARD B. ACCEPTED FOR USE UNDER PRESCRIBED CODE TEST METHODS.
- 6. GENERAL CONTRACTOR SHALL COORDINATE HIS/HER WORK WITH THAT OF OTHER SUBCONTRACTORS AND SUPPLIERS.
- 7. CONTRACTOR SHALL PATCH AND REPAIR ALL SURFACES OPENED DURING THE INSTALLATION OF THE WORK AND REPAIR ALL EXISTING AREAS THAT REMAIN DAMAGED DURING THE PERFORMANCE OF THE WORK.
- 8. ALL DRAWINGS, SPECIFICATIONS AND CONSTRUCTION NOTES ARE COMPLEMENTARY, AND WHAT IS CALLED FOR BY ONE WILL BE BINDING AS IF CALLED FOR BY ALL; ANY WORK SHOWN OR REFERRED TO ON ANY DOCUMENT SHALL BE PROVIDED AS THOUGH SHOWN ON ALL DOCUMENTS.
- 9. THE CHARACTER AND SCOPE OF WORK ARE ILLUSTRATED BY THE DRAWINGS. TO INTERPRET AND EXPLAIN THE DRAWINGS, OTHER INFORMATION DEEMED NECESSARY BY THE ARCHITECT WILL BE FURNISHED TO THE CONTRACTOR WHEN AND AS REQUIRED BY THE WORK, AND IT IS TO BE UNDERSTOOD THAT THE SAID ADDITIONAL DRAWINGS ARE TO BE OF EQUAL FORCE WITH THE DRAWINGS AND SHALL BE CONSIDERED AS FORMING PART OF THESE NOTES TO WHICH THEY REFER.
- 10. CONTRACTOR SHALL NOT OBSTRUCT ACCESS TO ROADWAYS AT ANY TIME.
- 11. ALL DIMENSIONS NOTED ON PLANS ARE TO ROUGH FRAMING UNLESS OTHERWISE NOTED.
- 12. CONTRACTOR SHALL REPORT ANY DISCREPANCIES BETWEEN THIS DOCUMENT AND CONTRACT DOCUMENTS ISSUED TO OTHERS PRIOR TO THE START OF THE WORK.
- 13. CONTRACTOR SHALL COMPLY WITH ALL REQUIREMENTS OF THE NEW YORK STATE BUILDING CODES, STATE LABOR LAW AND ALL REGULATIONS OF NEW YORK STATE AND OTHER GOVERNMENT AGENCIES. ALL PERMITS SHALL BE PROPERLY DISPLAYED.
- 14. PENETRATION IN OPENINGS OF WALL PARTITIONS OR FLOORS FOR PIPE SLEEVES, ELECTRICAL DEVICES, ETC. SHALL BE PACKED AND SEALED OR OTHERWISE ISOLATED TO MAINTAIN THE REQUIRED FIRE STOPPING AND SOUND TRANSMISSION CLASSIFICATION RATING.
- 15. ALL ELECTRICAL WORK SHALL BE DONE IN ACCORDANCE WITH ANY AND ALL APPLICABLE CODES.
- 16. ALL PLUMBING & HVAC WORK SHALL BE DONE IN ACCORDANCE WITH ANY AND ALL APPLICABLE CODES.
- 17. MECHANICAL DESIGN-BUILD SHALL BE BY OTHERS.
- 18. IF, IN THE INTERPRETATION OF CONTRACT DOCUMENTS, REQUIREMENTS WITHIN THE DRAWINGS AND SPECIFICATIONS CONFLICT, OR IT APPEARS THAT THE DRAWINGS AND SPECIFICATIONS ARE NOT IN AGREEMENT, THE REQUIREMENT TO BE FOLLOWED SHALL BE DECIDED BY THE ARCHITECT. WHERE THERE IS A DISCREPANCY IN THE QUANTITY, THE CONTRACTOR SHALL PROVIDE THE GREATER QUANTITY; WHERE THERE IS A DISCREPANCY IN THE QUALITY, THE CONTRACTOR SHALL PROVIDE THE SUPERIOR QUALITY.
- 19. THE CONTRACTOR IS RESPONSIBLE FOR FURNISHING AND INSTALLING ALL COMPONENTS, ACCESSORIES, ETC. FOR A COMPLETE PROJECT INCLUDING ITEMS NOT SHOWN IN THESE CONSTRUCTION DRAWINGS.
- 20. ALL PRODUCTS ARE TO BE INSTALLED IN STRICT CONFORMANCE W/ MANUFACTURER'S INSTALLATION INSTRUCTIONS. NO EXCEPTIONS.

RENOVATIONS FOR:

LDD PROPERTIES 18 CHURCH STREET FISHKILL, NY 12524

FIRE EXTINGUISHER WALL MTD.

LONG LEG HORIZONTAL

MOP & BROOM HOLDER

MANUFACTURE / MANUFACTURER

LONG LEG VERTICAL

MATERIAL MAXIMUM

METAL MEZZANINE

MIRROR

MOULDING

MASONRY OPENING METAL PANEL MOISTURE RESISTANT

GYPSUM BOARD

ABBREVIATIONS

ALUM ANOD AP

B/ BLDG BLKG BM/BMS BOS

CL CLG CLO CLR CMU COL CONC CONF CONT CONTR CORR CSMU

EMO EQ EQUIP

ACOUSTICAL CEILING TILE

ELECTRIC HAND DRYER

ELECTRIC WATER COOLER

EXISTING WINDOW OPENING

EMERGENCY

EQUIPMENT

EXTERIOR

EGRESS UNIT

EXPANSION JOINT

EQUAL

E.U. EGRESS UN
EWC ELECTRIC \
EWO EXISTING \
EXHIB EXHIBIT
EXIST/EXIST'G EXISTING

EXTERIOR INSULATION FINISH SYSTEM

MAS MAT MAX MBH MECH

MEZZ MFGR MIN

	ADDENDUM	FD	FLOOR DRAIN	NIC	NOT IN CONTRACT	T/	TOP OF
	ADJACENT	FIN	FINISH	NO	NUMBER	T&G	TONGUE AND GROOVE
	ABOVE FINISHED FLOOR	FIX	FIXTURE	NOM	NOMINAL	T/S	TOP OF STEEL
	ALTERNATE	FL	FLOOR	NTS	NOT TO SCALE	TB	TACK BOARD
	ALUMINUM	FND	FEMININE NAPKIN DISPOSAL	NIO	NOT TO SOME	TCB	TECTUM BOARD
	ANODIZED FINISH	FNDN	FOUNDATION	OC	ON CENTER	TEL	TELEPHONE
	ACOUSTICAL PANEL			OH			TEMPERED
v	APPROXIMATE	FNV	FEMININE NAPKIN VENDOR		OVERHEAD	TEMP	
X	· · · · · · · · · · · · · · · · · · ·	FRP	FIBER REINFORCED PLASTIC	OPNG	OPENING	TERR	TERRAZZO
	ARCHITECT/ARCHITECTURAL	FT	FEET	OPP HD	OPPOSITE HAND	TG	TEMPERED GLASS
;	ASSOCIATED	FTG	FOOTING			THK	THICK
	AUDIO VISUAL	FURN	FURNISH / FURNITURE	PART	PARTITION	THRU	THROUGH
		FUR	FURRED / FURRING	PC	PLUMBING CONTRACTOR	TOC	TOP OF CONCRETE
	BULLETIN BOARD	FR	FIRE RESISTANT	PF	PRE-FINISHED	TOF	TOP OF FOOTING
	BOTTOM OF	FEC	FIRE EXTINGUISHER CABINET	PL	PLATE	TOM	TOP OF MASONRY
	BUILDING			PL LAM/PLAS LAM	PLASTIC LAMINATE	TPH	TOILET PAPER HOLER
	BLOCKING			PLAST	PLASTER	TS	TACK STRIP
		GA	GUAGE	PLMBG	PLUMBING	TYP	TYPICAL
5	BEAM/BEAMS	GAL	GALLON	PLY/PLYWD	PLYWOOD		11110/12
	BOTTOM OF SOFFIT	GALV	GALVANIZED	PNL	PANEL		
)	BOARD	GB	GRAB BAR	P/PNT	PAINT	UG	UNDERGROUND
	BEARING	GC	GENERAL CONTRACT	POL	POLISH	UH	UNIT HEATER
	BASEMENT	GCT	GRANITE COUNTER TOP			UL	UNDERWRITERS LABATORIES
		GL	GLASS / GLAZING	PR	PAIR	UNO/UON	UNLESS OTHERWISE NOTED
	OARRET	GND	GROUND	PT	POINT	U/S	UNDERSIDE
	CARPET	GYP WALL BD/GWB	GYPSUM WALL BOARD	PTD	PAPER TOWEL DISPENSER	UTIL	UTILITY
	CABINET	GTF WALL DD/GWD	GTF SOW WALL BOARD	PTN	PARTITION	UV	UNIT ELEVATOR
	CHALKBOARD			PVC	POLY VINYL CHLORIDE	OV	ONIT ELEVATOR
	CONTROL JOINT			PGB	PAINTED GYPSUM BOARD		
	CENTER LINE	Н	HIGH	PS	PROJECTION SCREEN	V	VINYL
	CEILING	H/C	DISABLED ACCESS			VCT	VINYL COMPOSIT TILE
	CLOSET	HD	HEAVY DUTY			VET	VERTICAL
	COOLER	HDR	HEADER	Q.T.	QUARRY TILE	VIF	VERIFY IN FIELD
	CONCRETE MASONRY UNIT	HDWR	HARDWARE			VTR	VENT THROUGH ROOF
	COLUMN	HM	HOLLOW METAL	R	RISER		
	CONCRETE	HORZ	HORIZONTAL	RAD	RADIUS		
	CONFERENCE	HR	HANDRAIL / HOUR	RCP	REFLECTED CEILING PLAN	W	WIDE
	CONTINUOUS	HT	HEIGHT	RD	ROOF DRAIN	W/	WITH
,	CONTRACTOR	HTG	HEATING	RE	REFER TO	WB	WHITEBOARD
	CORRIDOR	HVAC	HEATING VENTILATION A/C	REFRIG	REFRIGERATOR	WC	WATER CLOSET
		HVAC	HEATING VENTILATION A/C	REOD	REQUIRED	WD	WOOD
	CALCIUM SILICATE MASONRY UNIT			RH	RIGHT HAND	WP	WATERPROOF
	CERAMIC TILE	ID	INSIDE DIAMETER			WR GWB	WATER RESISTANT GYPSUM BR
	CERAMIC TILE BASE	INSUL	INSULATION	RHR	RIGHT HAND REVERSE	WINGWD	WATER RESISTANT STESON BR
		INV	INVERT	RM	ROOM		
		IIV	INVLIXI				
	DOUBLE ACTING	JAN	JANITOR	S	SEALER		
TL .	DETAIL	JAN JT		SAT	SATURATION		
	DRINKING FOUNTAIN	JI	JOINT	SC	SOLID CORE WOOD DOOR		
	DIAMETER			SD	SOAP DISPENSER		
	DISPENSER	KPL	KICKPLATE	SF	SQUARE FEET		
	DIVISION			SHT	SHEET		
	DOWN	L	LAMINATED GLASS	SIM	SIMILAR		
	DOOR	LAV	LAVATORY	SPEC	SPECIFICATION		
	DOWNSPOUT	LF	LINEAR FEET	SPD	SOAP DISH		
	DRAWING	LF LH	LEFT HAND				
	2			SQ	SQUARE		
		LHR	LEFT HAND REVERSE	SST	STAINLESS STEEL		
		LIN	LINIEN	CTI/CT	C FEEL		

NONCOMBUSTIBLE

STRUCTURAL / STRUCTURE

SHEET VINYL FLOORING

SUSPENDED

SHEAR WALL

DRAWING LIST

TITLE SHEET

DWG. # DRAWING NAME

DEMO SITE PLAN PROPOSED SITE PLAN ALTERNATIVE SITE PLAN PHOTOMETRIC PLAN & LIGHTING SPECS SITE DETAILS PROPOSED EXTERIOR ELEVATIONS 7A1.1 PROPOSED FLOOR PLANS EXISTING FLOOR PLANS EXISTING ELEVATION PHOTOS PARKING SKETCHES

EXISTING CONSTRUCTION TO REMAIN

EXISTING CONSTRUCTION TO BE DEMOLISHED

NEW CONSTRUCTION

EXTERIOR ELEVATION

INTERIOR ELEVATION

OWNER'S CERTIFICATION

THE UNDERSIGNED OWNER OF THE PROPERTY SHOWN HEREON, HEREBY CERTIFY THAT WE ARE FAMILIAR WITH THIS MAP, ITS CONTENTS AND DETAILS AND HEREBY AGREE TO THE TERMS AND CONDITIONS EXPRESSED HEREON.

OWNER'S NAME/ADDRESS

DATE

VILLAGE OF FISHKILL PLANNING BOARD

APPROVED BY RESOLUTION OF THE PLANNING BOARD OF THE VILLAGE OF FISHKILL, NEW YORK ON THE _____ DAY OF __ 20___, SUBJECT TO ALL REQUIREMENTS AND CONDITIONS OF SAID RESOLUTION. ANY CHANGES, ERASURES, MODIFICATIONS, OR REVISIONS OF THIS SITE PLAN AS APPROVED, SHALL VOID THIS APPROVAL.

PLANNING BOARD CHAIRPERSON


DATE

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DRAWN BY 1 OF 11 $\mathbf{A}\mathbf{A}$ 9/4/25

As indicated **DRAWING NO:**

PROJECT PHASE:

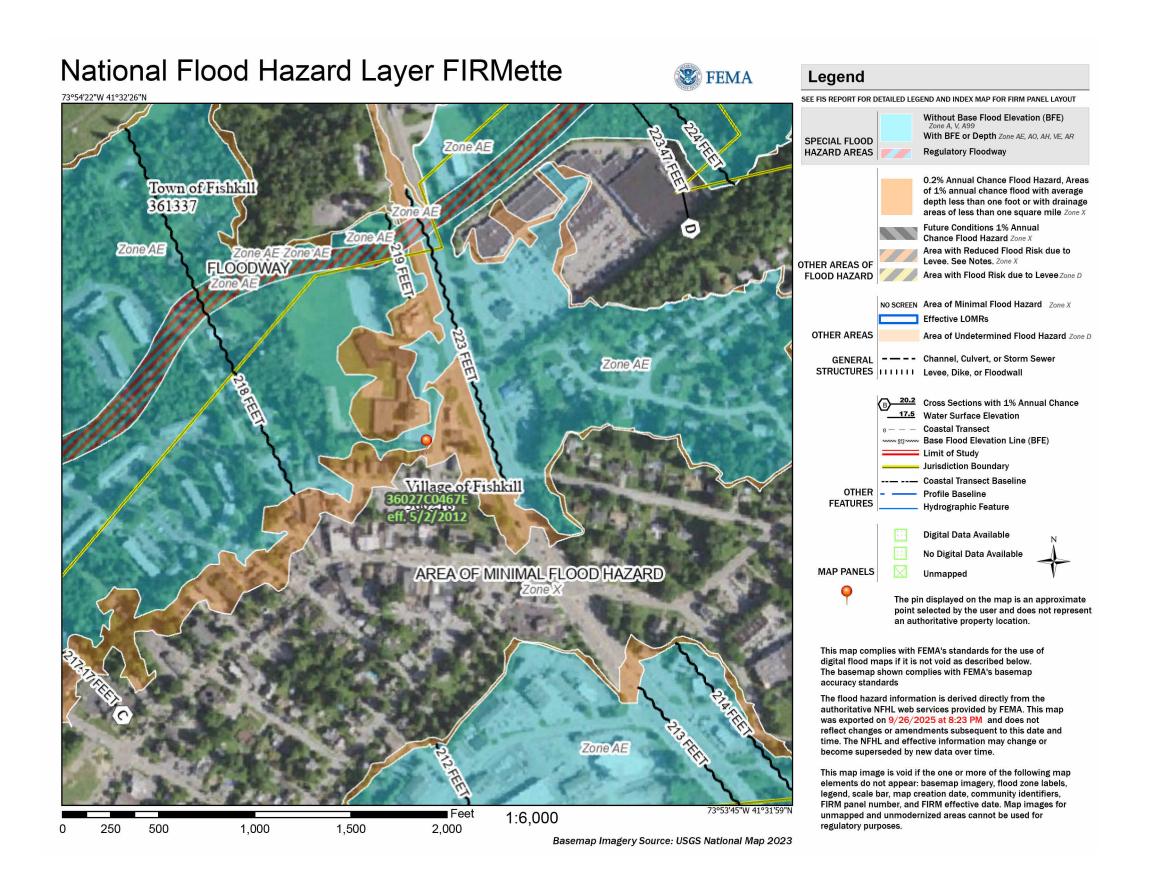


VILLAGE OF FISHKILL SECTION 165


1. No persons shall tap any street main or make connection therewith, except authorized personnel of the Village of Fishkill, unless such tapping is made as an adjunct to a contract with the village for the installation of street mains on which such tap is being made. The cost of such tap made by the village shall have fixed prices which shall be paid in advance. The village shall tap all mains, except as noted above or as hereinafter noted, and shall approve the setting of all meters, and no one shall turn on any water service nor shut off any water service except with the knowledge of and permission of the Village Board.

- 2. No person shall lay any service main or make any attachment thereto or any alterations or repairs to the service main or appurtenances thereto except by permission of the village as prescribed in § 165-21 above or by persons or firms working under contract with the village for such work.
- 3. There shall be no tap, provision for a tap, plugged tee or other such fitting in the service main between the street main and the meter inside the building. Any yard hydrant, fountain or hose must be connected on the building side of the meter or service.
- 3. All service pipe shall be of the best grade and weight standard, Type K copper tubing of sizes through two (2) inches, meeting AWWA Specification 7S-CR. Service pipe over two (2) inches shall be cast iron or ductile iron meeting AWWA Specifications C106-62 and C151-65, respectively. All pipe shall be rated for service of one hundred fifty (150) pounds per square inch or greater. No service shall be less than three-fourths (3/4)


- 4. Service pipe shall be laid not less than four and one-half (4 1/2) feet below the surface of grade, and its vertical and horizontal alignment in relation to any sewer or other parallel pipe shall conform to Health Department standards and other village local
- 5. Only one (1) property or property unit shall be supplied through a single service pipe. Should repairs to the service main or its appurtenances and fixtures become necessary to prevent waste of water or to maintain service, the repair and the cost of such repair will be made by and at the expense of the public district if the defect is located between the street main and the curb stop. If the defect is between the curb stop and the building, the repair and full cost of such repair shall be the responsibility of the owner of the premises. Failure to immediately repair such defect shall cause the Water Department to turn off the water at the curb stop
- 6. Every service main shall have a cock or other approved valved tap in the main, an inverted key stop cock or other approved valve with a metal protecting box at the curb or property line and a gate valve or other approved valve just before the meter. It shall be the duty and responsibility of the property owner to keep the curb box in good repair, above ground and accessible at all time.



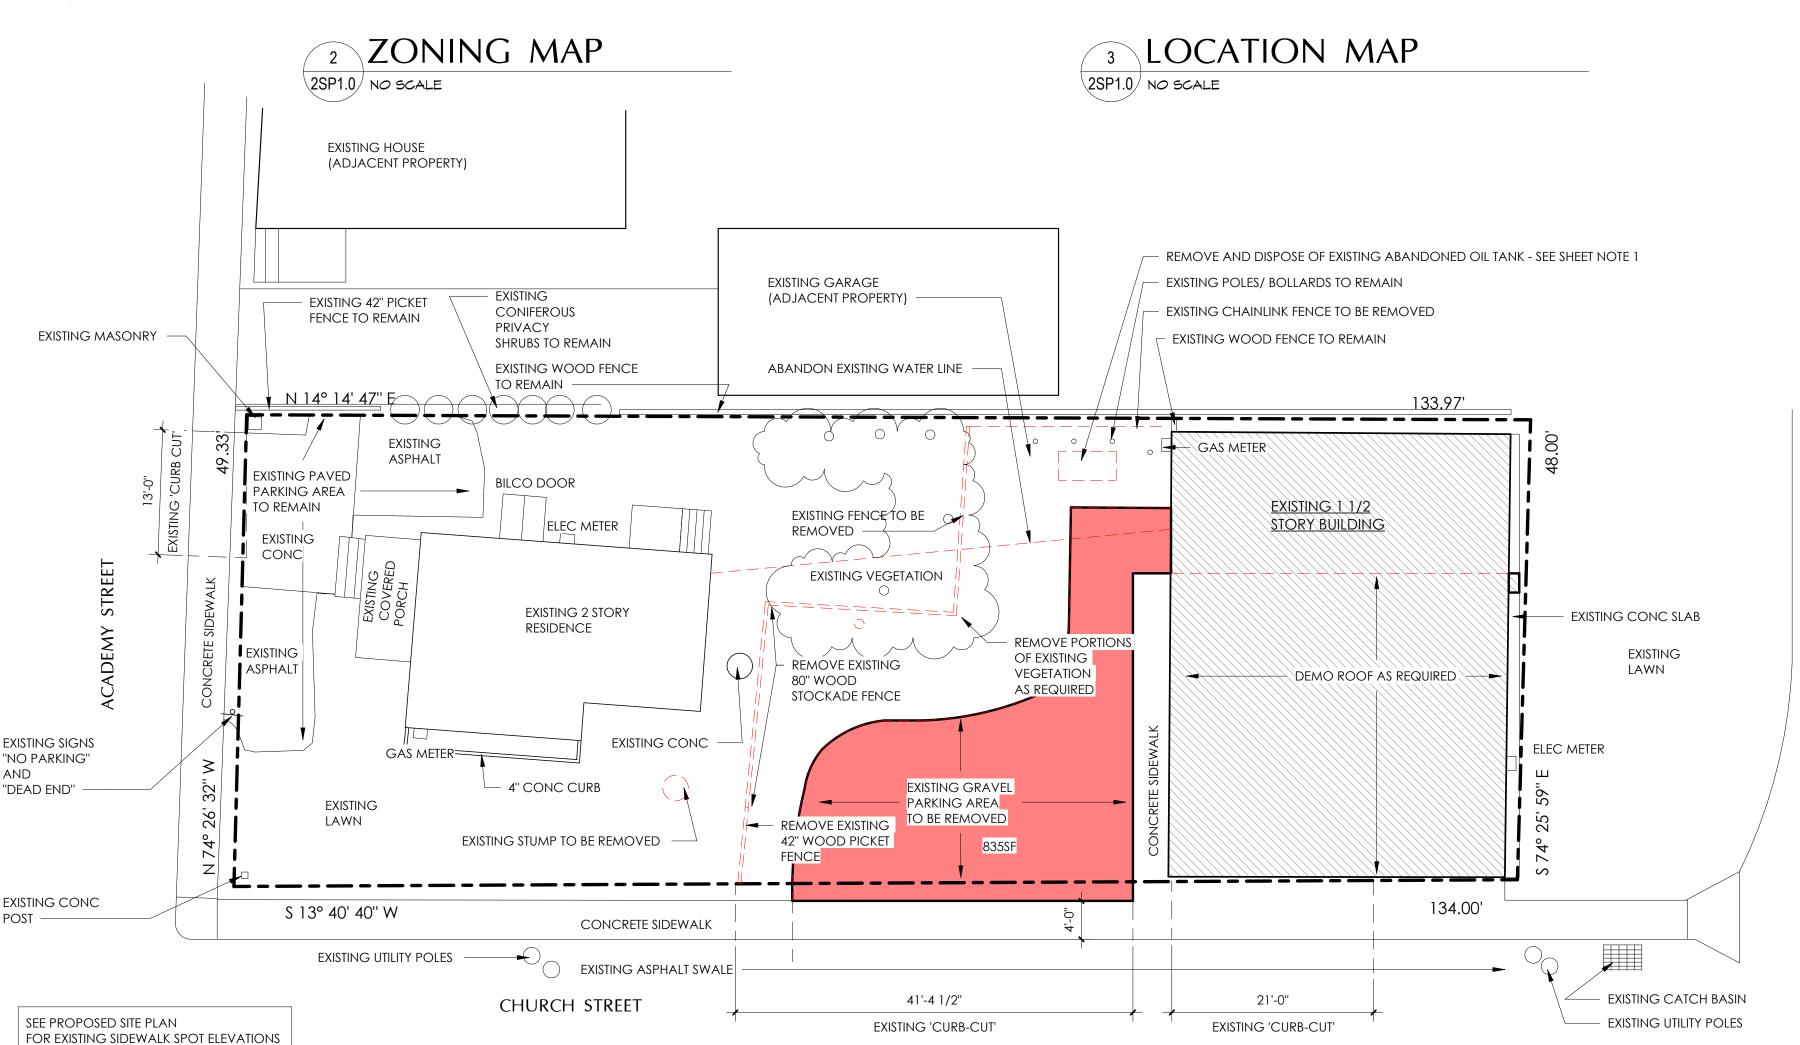

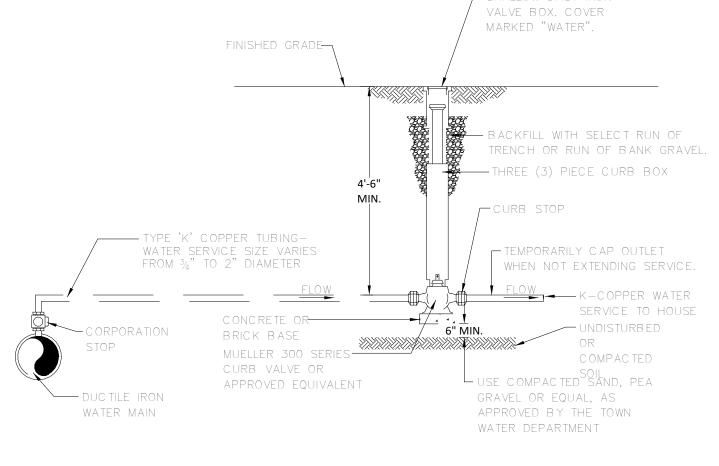

1. MINIMUM DISTANCE TO JOINTS, FITTINGS OR OTHER WET TAPS OR STOPS SHALL BE MAINTAINED AS PER 2. SHALLOW CAST IRON VALVE BOX MAY BE ELIMINATED AND CAST IRON COVER MAY BE RAISED 4"-6" ABOVE GRADE IN AREAS THAT ARE LANDSCAPED OR WHERE THE CURB BOX DOES NOT CREATE A TRIPPING HAZARD. 3. FOR MORE DETAILS REGARDING WATER SERVICE CONNECTIONS REFER TO THE VILLAGE OF FISHKILL CODE,

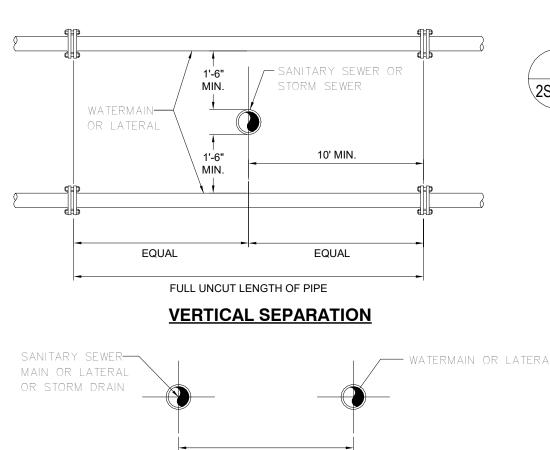

HORIZONTAL SEPARATION NO DEVIATION IN THE SEPARATION REQUIREMENTS WILL BE PERMITTED WITHOUT THE

WHERE SEPARATION DISTANCES CANNOT BE MAINTAINED.

EXPRESS APPROVAL OF THE DUTCHESS COUNTY DEPARTMENT OF HEALTH. CONCRETE

ENCASEMENT OF WATER LINE OR OFFSETTING OF WATER LINE SHALL BE REQUIRED

EXISTING/ DEMO SITE PLAN

R-50 -

PARCEL BOUNDARIES MUNICIPAL BOUNDARIES

LC, LAND CONSERVATION

GB-1, GENERAL BUSINESS DISTRICT GB-2 GENERAL BUSINESS DISTRICT

PB, PLANNED BUSINESS DISTRICT

VC-BD, VILLAGE CENTER BUSINESS DISTRICT

HISTORIC PRESERVATION OVERLAY

Zoning Districts

SHEET NOTES

1. FOLLOW ALL VILLAGE OF FISHKILL AND NYS DEC REULATIONS FOR PROPER DISPOSAL AND REMOVAL OF EXISTING OIL TANK

OWNER'S CERTIFICATION

THE UNDERSIGNED OWNER OF THE PROPERTY SHOWN HEREON, HEREBY CERTIFY THAT WE ARE FAMILIAR WITH THIS MAP, ITS CONTENTS AND DETAILS AND HEREBY AGREE TO THE TERMS AND CONDITIONS EXPRESSED HEREON.

OWNER'S NAME/ADDRESS DATE

VILLAGE OF FISHKILL PLANNING BOARD

APPROVED BY RESOLUTION OF THE PLANNING BOARD OF THE VILLAGE OF FISHKILL, NEW YORK ON THE _____ DAY OF 20___, SUBJECT TO ALL REQUIREMENTS AND CONDITIONS OF SAID RESOLUTION. ANY CHANGES, ERASURES, MODIFICATIONS, OR REVISIONS OF THIS SITE PLAN AS APPROVED, SHALL VOID THIS APPROVAL.

2 OF 11 9/4/25 **DRAWING NO:** PROJECT PHASE:

As indicated


PB

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ations

PLANNING BOARD CHAIRPERSON DATE



LUMINAIRE SCHEDULE									
SYMBOL	QUANTITY	LAMP	COLOR	MOUNTING	HEIGHT ABOVE GRADE				
A	1	GST PARKING LIGHT BY GSI	BLACK	WALL	10'-9"				
B	2	BARNLIGHT 'WAREHOUSE' GOOSENECK G22 12" - ENTRY DOORS WALL MOUNTED	BLACK	WALL	7'-3 1/2'"				

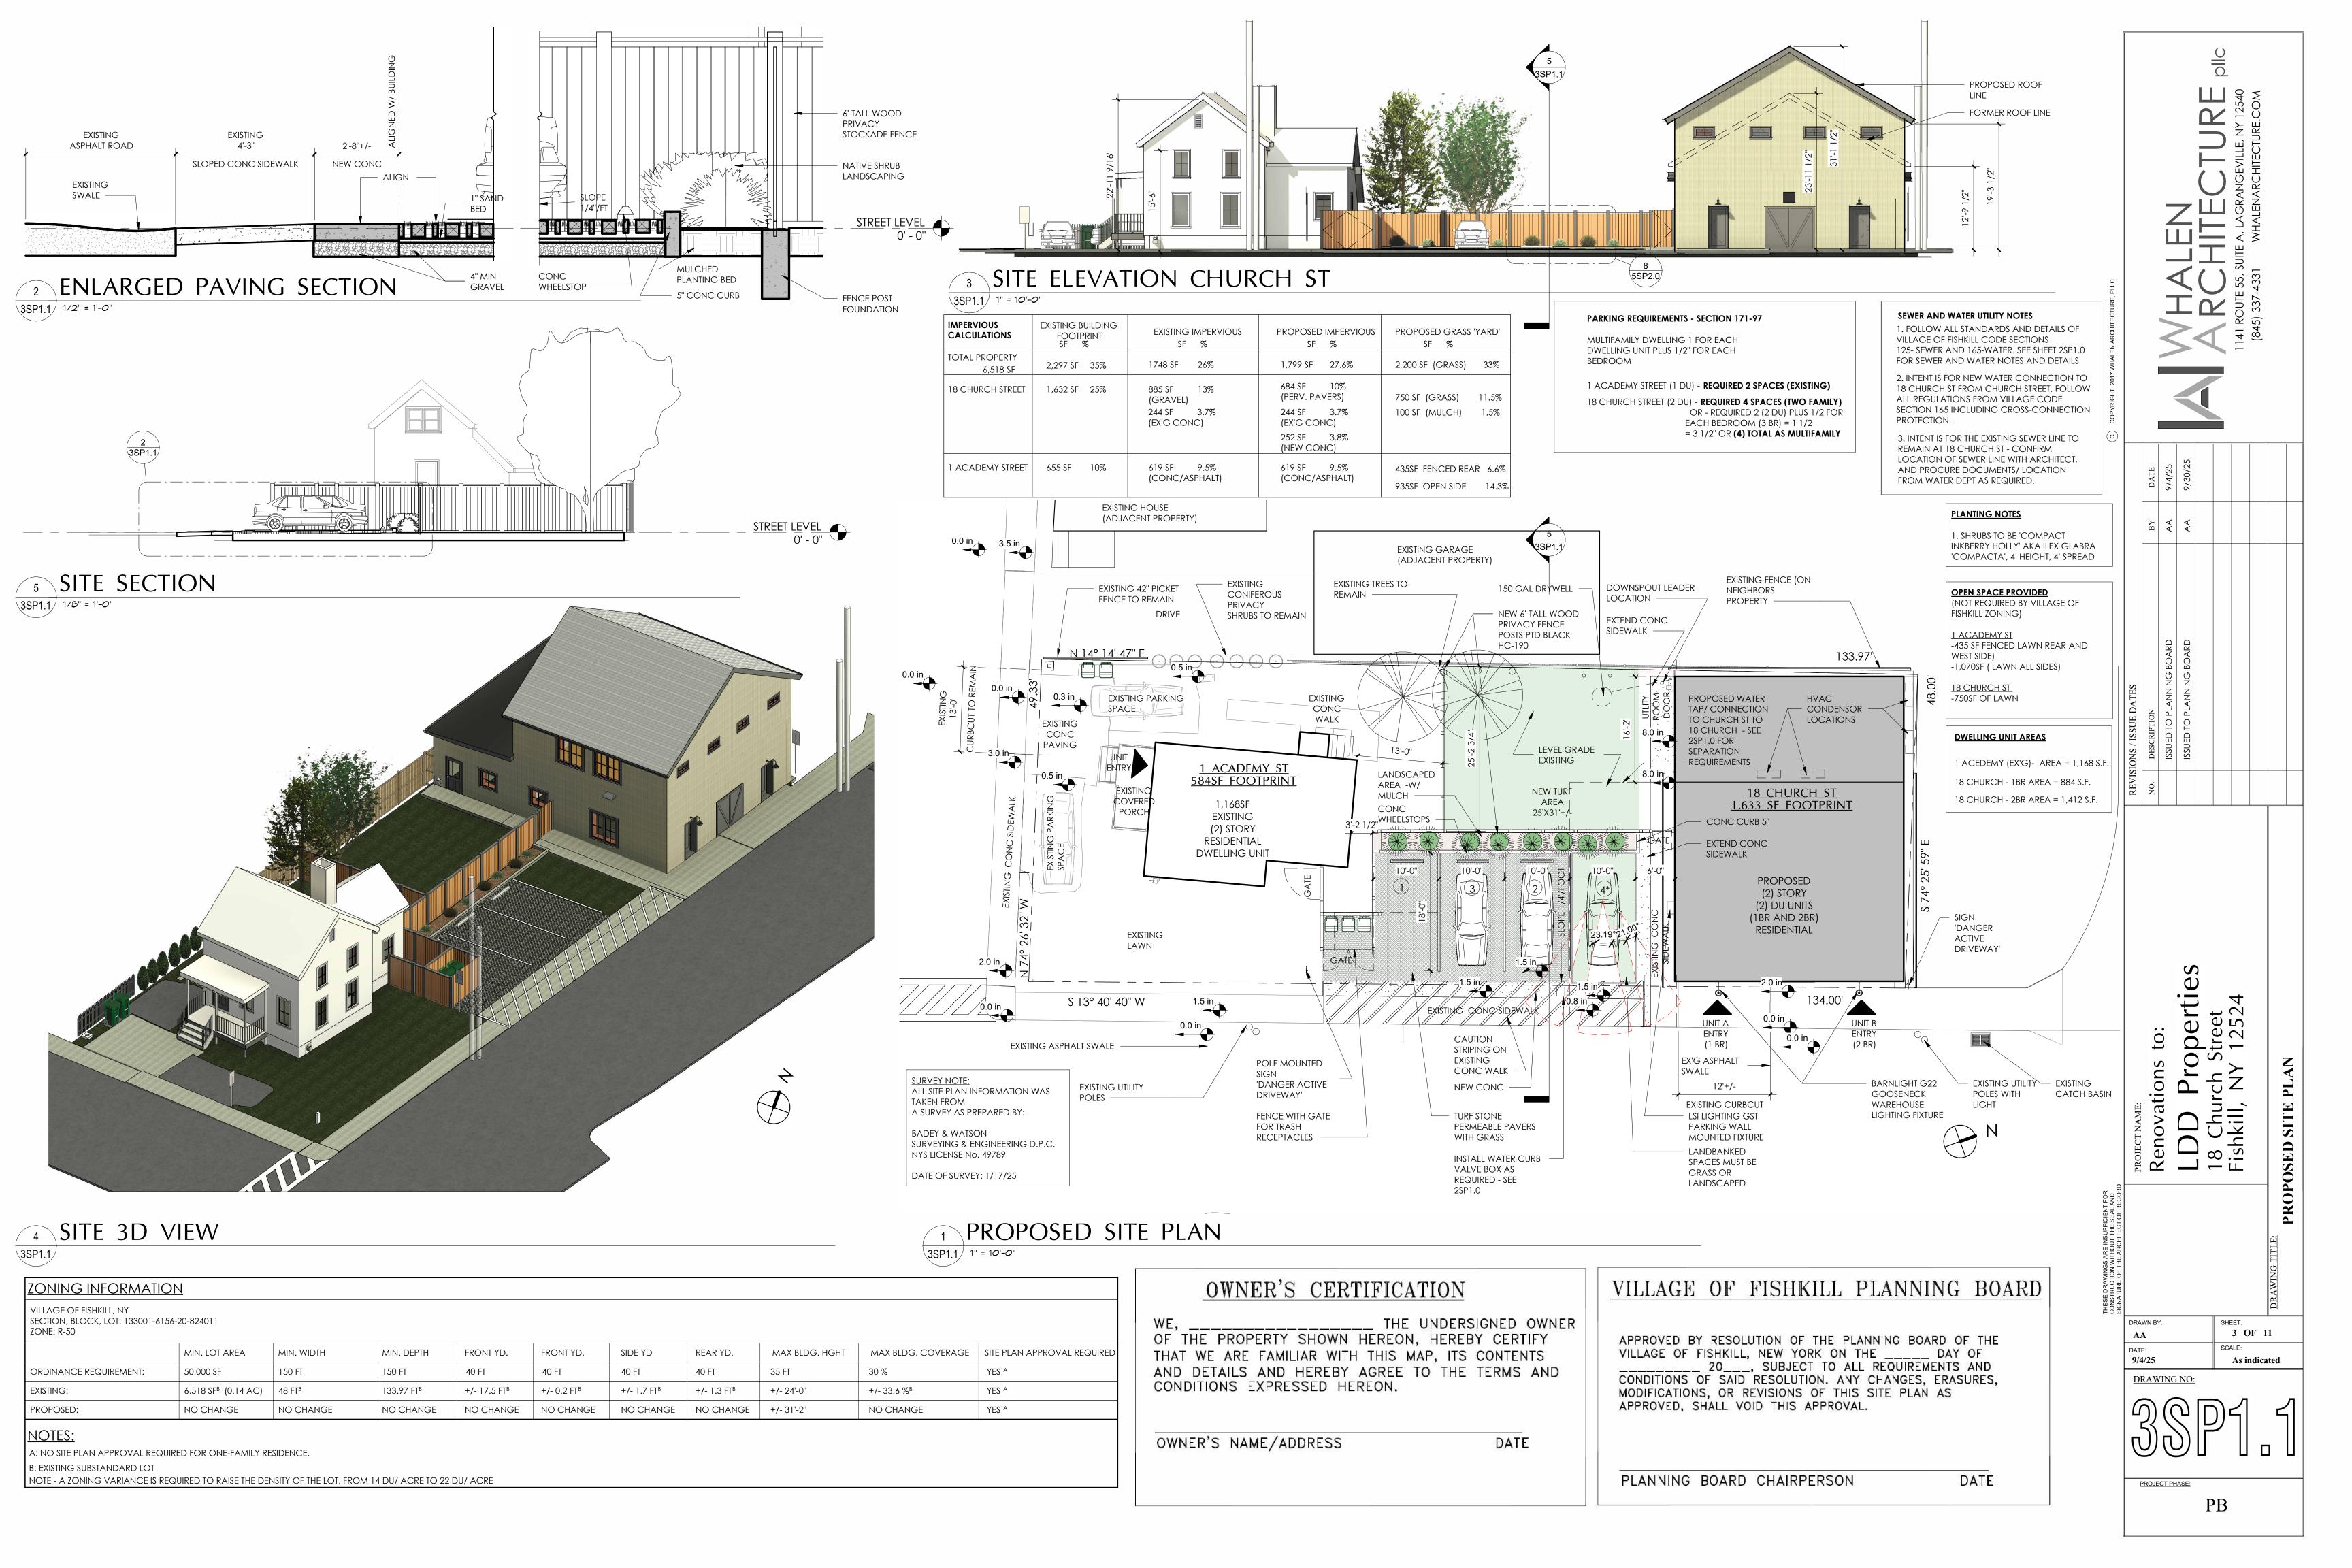LIGHTING NOTES

LIGHTS WILL BE SET TO BE MOTION SENSOR ACTIVATED BETWEEN THE HOURS OF 10 PM AND 6 AM.
 ALL LIGHTING FIXTURES ARE TO BE COMPLIANT WITH STANDARDS SET BY THE INTERNATIONAL DARK-SKY ASSOCIATION.

NOTE:
ALL NEW LIGHTS TO HAVE A COLOR TEMPERATURE
OF NO GREATER THAN 3,000K.




BARNLIGHT 'WAREHOUSE' GOOSENECK G22 12" - ENTRY DOORS WALL MOUNTED

Geometric Sconces (GST/GSR/GSQ)



GST BY LSI - PARKING LIGHT

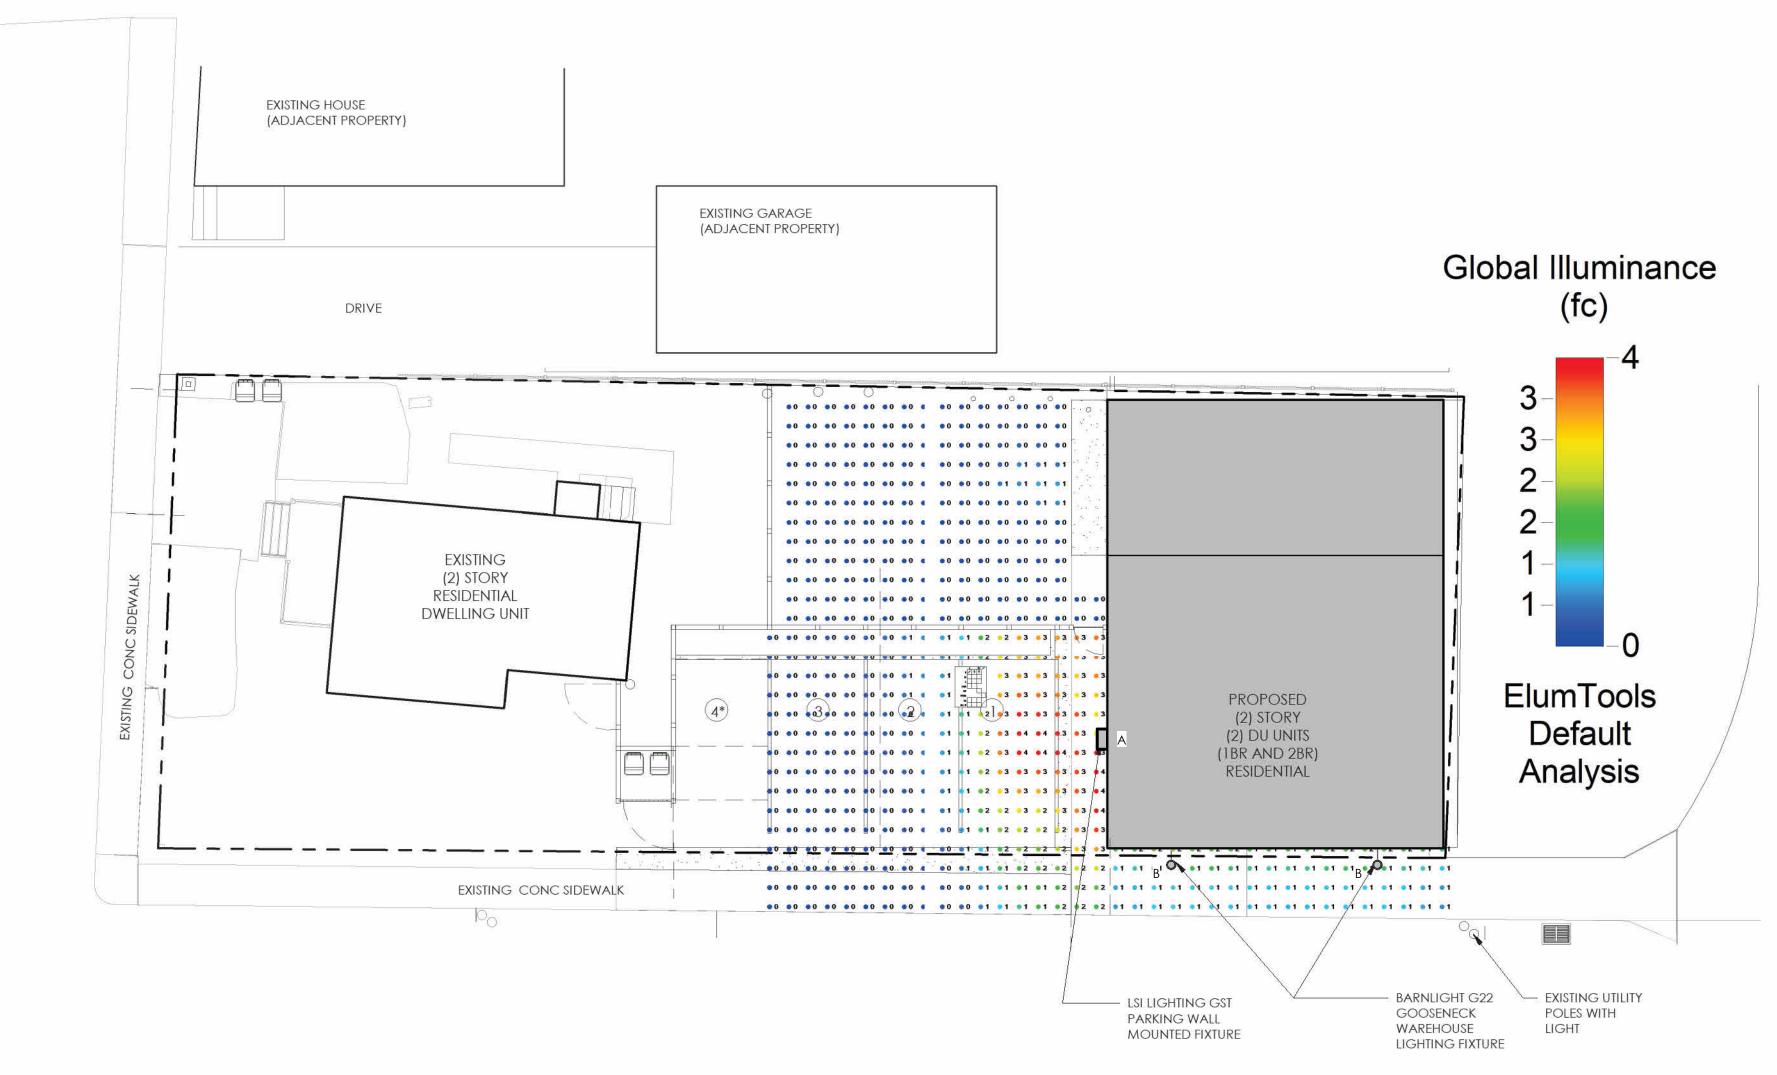

PROPOSED PHOTOMETRIC PLAN

OWNER'S CERTIFICATION

WE, _____ THE UNDERSIGNED OWNER OF THE PROPERTY SHOWN HEREON, HEREBY CERTIFY THAT WE ARE FAMILIAR WITH THIS MAP, ITS CONTENTS AND DETAILS AND HEREBY AGREE TO THE TERMS AND CONDITIONS EXPRESSED HEREON.

OWNER'S NAME/ADDRESS

DATE

VILLAGE OF FISHKILL PLANNING BOARD

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PLANNING BOARD CHAIRPERSON


DATE

perties 4 OF 11 SW9/4/25 1/4" = 1'-0"**DRAWING NO:**


PROJECT PHASE:

PB

2 LIGHTING SPECS

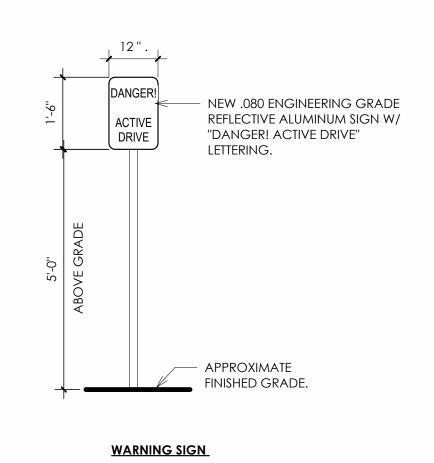


SIGN DETAIL \5SP2.0/ 1/2" = 1'-0"

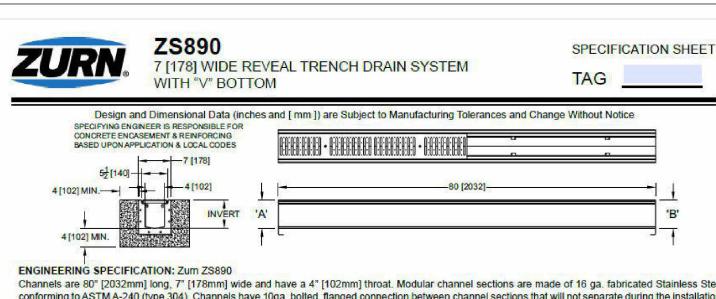


Channels are 80" [2032mm] long, 7" [178mm] wide and have a 4" [102mm] throat. Modular channel sections are made of 16 ga. fabricated Stainless Steel conforming to ASTM A-240 (type 304). Channels have 10ga, bolted, flanged connection between channel sections that will not separate during the installation, gaskets available. Channels weigh less than 2.31 lbs. [1.05kg] per linear foot, have a smooth, 1-1/2" [38mm] radiused self cleaning bottom with a Manning's coefficient of .009 and 1.04% or neutral 0% built in slope. Channels have feet for patty pour or leveling studs standard to secure trench in its final location. Channels are provided with standard FS grates that lock down to frame. Zurn 6" [152mm] wide reveal Fabricated Stainless Steel Grate conforming to ASTM specification A-240, (type 304), is rated class A per the DIN EN1433 top load classification. Supplied in 40" [1016mm] nominal lengths with 5/16" [8mm] wide slots, and 3/4" [19mm] bearing depth. Grate has an open area of 12.00 sq. in per ft. [7,742 sq. mm per meter]. Channels shall be produced in the U.S.A.


STEEL SPIKE METHOD (ASPHALT H-2310) 3. Reposition the parking block in its installation position. Drive the spike through the parking block and into the Recommended for asphalt or wood block surfaces only. drilled hole until the spike is snug against the counterored surface of the parking block's pre-drilled hole. 1. Position the parking block in its installation position and, using its pre-drilled holes as templates, mark the location for each hole on the parking surface. Remove the parking block. Using a high-speed hammer drill and a 3/8" masonry bit, drill a hole through the parking surface of each marked location to avoid fracturing the asphalt with the spike. 6', PLASTIC, YELLOW.

² PARKING STOP DETAIL SSP2.0/ NO SCALE

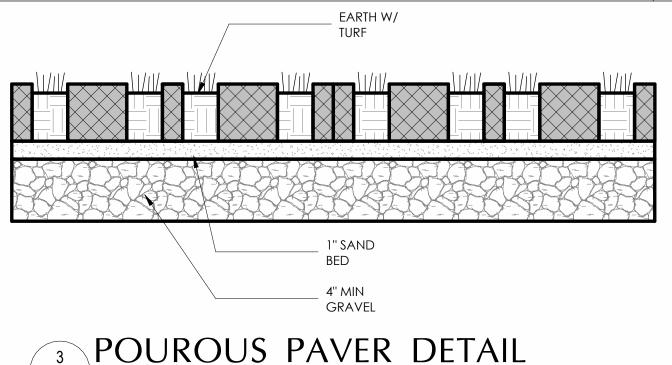



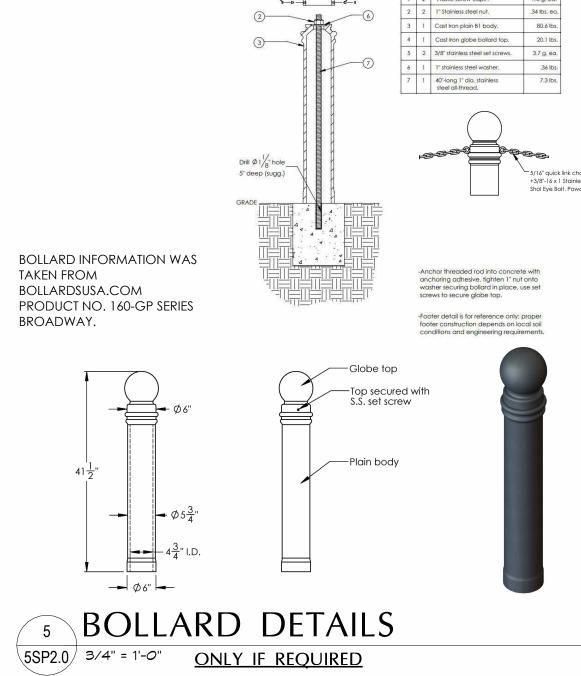

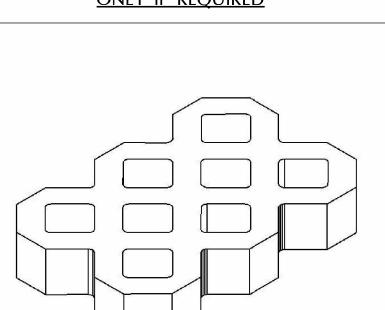



TURFSTONE - PERVIOUS PAVER PRODUCT INFO

$\sqrt{5SP2.0}$ 1 1/2" = 1'- $\overline{0}$ " SUBSURFACE DRAINAGE - ONLY IF REQUIRED



The Recharger® 330XLHD is a 30" (762 mm) tall, high capacity chamber. Typically when using this model, fewer chambers are required resulting in less labor and a smaller installation area. The Recharger® 330XLHD has the side portal internal manifold feature. HVLV® FC-24 Feed Connectors are inserted into the side portals to create the internal manifold.

Visit our website for more information.

We Have Solutions.

© CULTEC September 2024 SUB330XLHD 09-24 330XLHD RESI submittal

CAD / PDF Drawings

Installation Instructions

Size (L x W x H)	8.5' x 52" x 30"
	2.59 m x 1321 mm x 762 mm
Installed Length	
R-model as Stand Alone Unit R-model as Row Starter Unit E-model as Row Middle Unit E-model as Row End Unit	102" 93" 84" 93"
Chamber Storage	7.46 ft³/ft
	0.69 m³/m
	52.21 ft³/unit
	1.48 m³/unit
Chamber Weight	73.0 lbs
	33.11 kg
Shipping	30 chambers/skid
	2,335 lbs/skid
	10 skids/48' flatbed
Max. Allowable Cover	12'
	3.66 m
Max. Inlet Opening in End Wall	24" HDPE, PVC
	600 mm HDPE, PVC
Max. Allowable O.D.	10" HDPE, 12" PVC
in Side Portal	250 mm HDPE, 300 mm PVC
Compatible Feed Connector	HVLV FC-24 Feed Connector




All above values are nominal.


Scan to

CULTEC


Learn More

Typical Residential Drainage Details

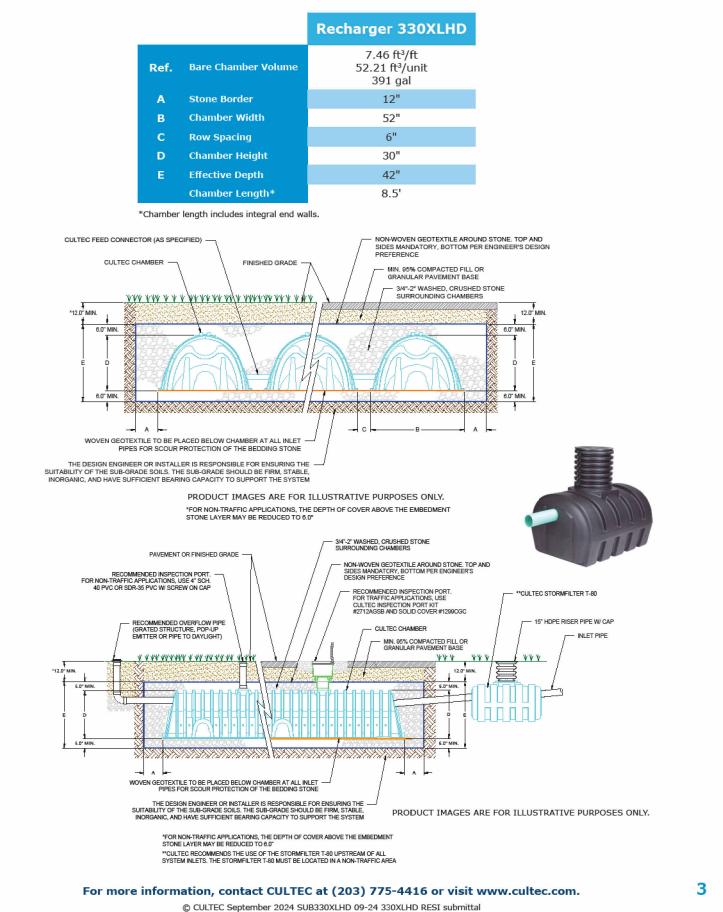

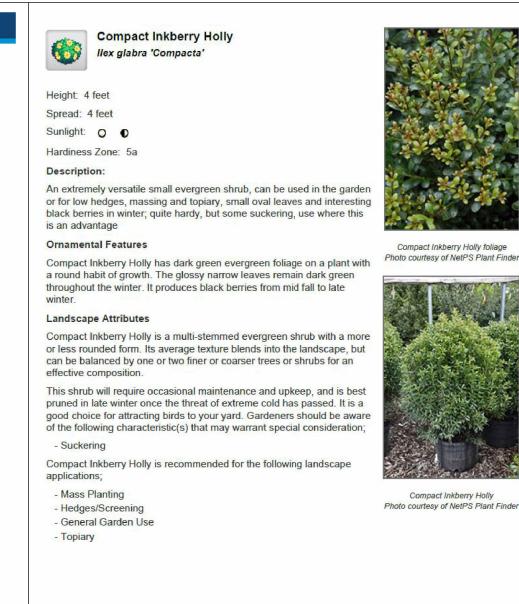

PLANTING - INKBERRY SHRUB

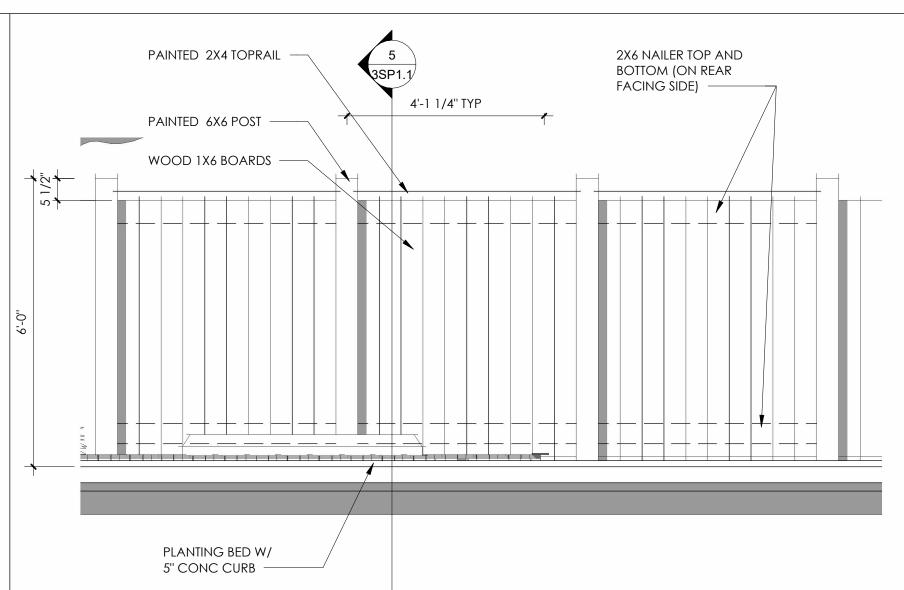

8 PROPOSED FENCE ELEVATION DETAIL \5SP2.0\/ 1/2" = 1'-0"

OWNER'S CERTIFICATION

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OWNER'S NAME/ADDRESS

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VILLAGE OF FISHKILL PLANNING BOARD

DATE

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PLANNING BOARD CHAIRPERSON

O be

4

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9/4/25 As indicated **DRAWING NO:**


5 OF 11

PROJECT PHASE: PB

SUBSURFACE DRAINAGE - ONLY IF REQUIRED


System Calculator

1.800.4.CULTEC

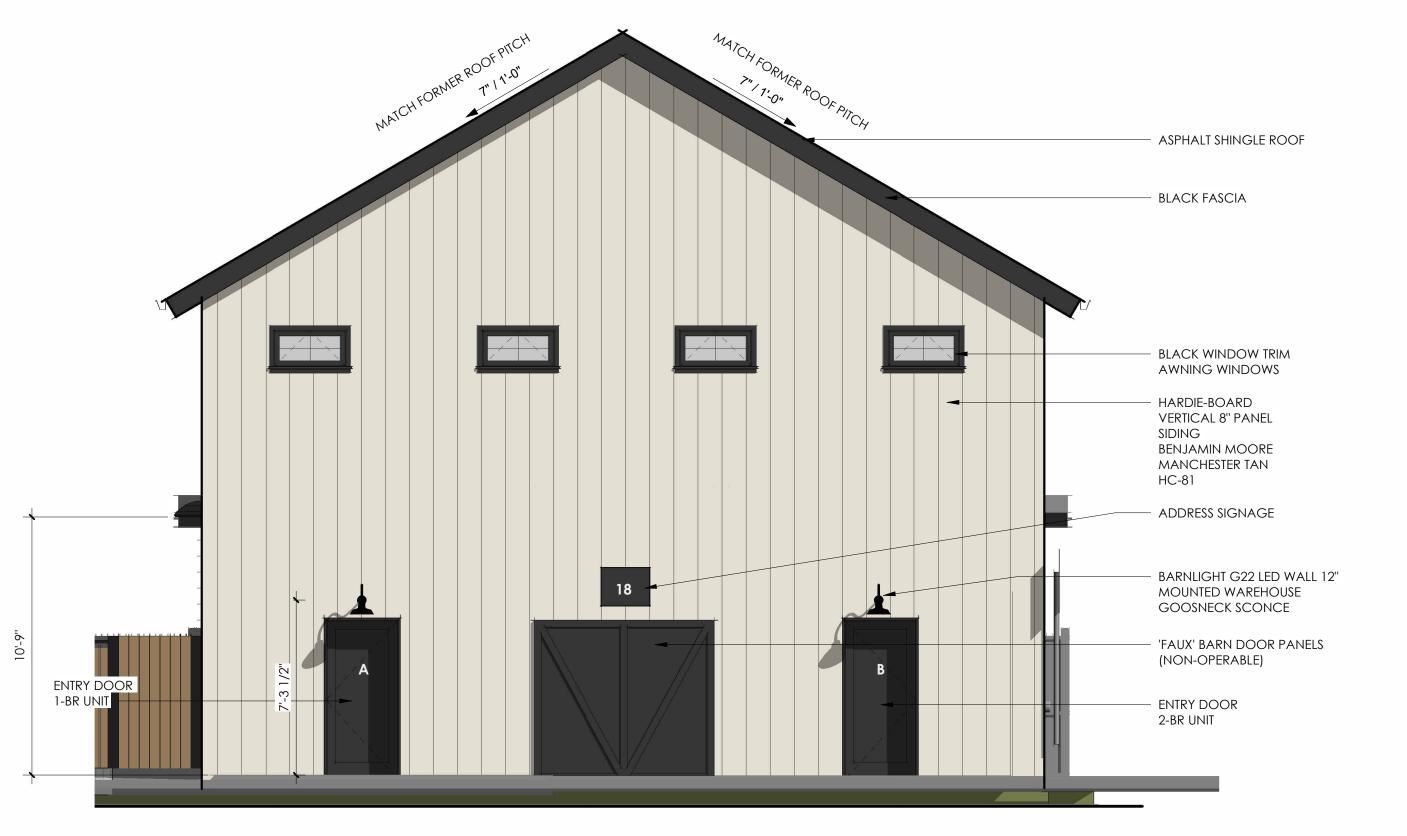






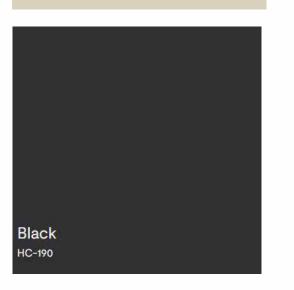

BENJAMIN MOORE HISTORIC COLORS PAINT



HARDIE-BOARD - VERTICAL 8"
PANELS CEMENT BOARD
SIDING - PRIMED

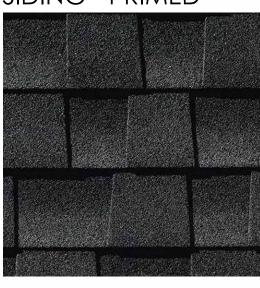

GAF - TIMBERLINE HDZ - CHARCOAL









RIGHT ELEVATION

6A1.0 1/4" = 1'-0"

6 OF 11


As indicated

 \mathbf{SW}

DATE: 9/4/25


DRAWING NO:

PROJECT PHASE:

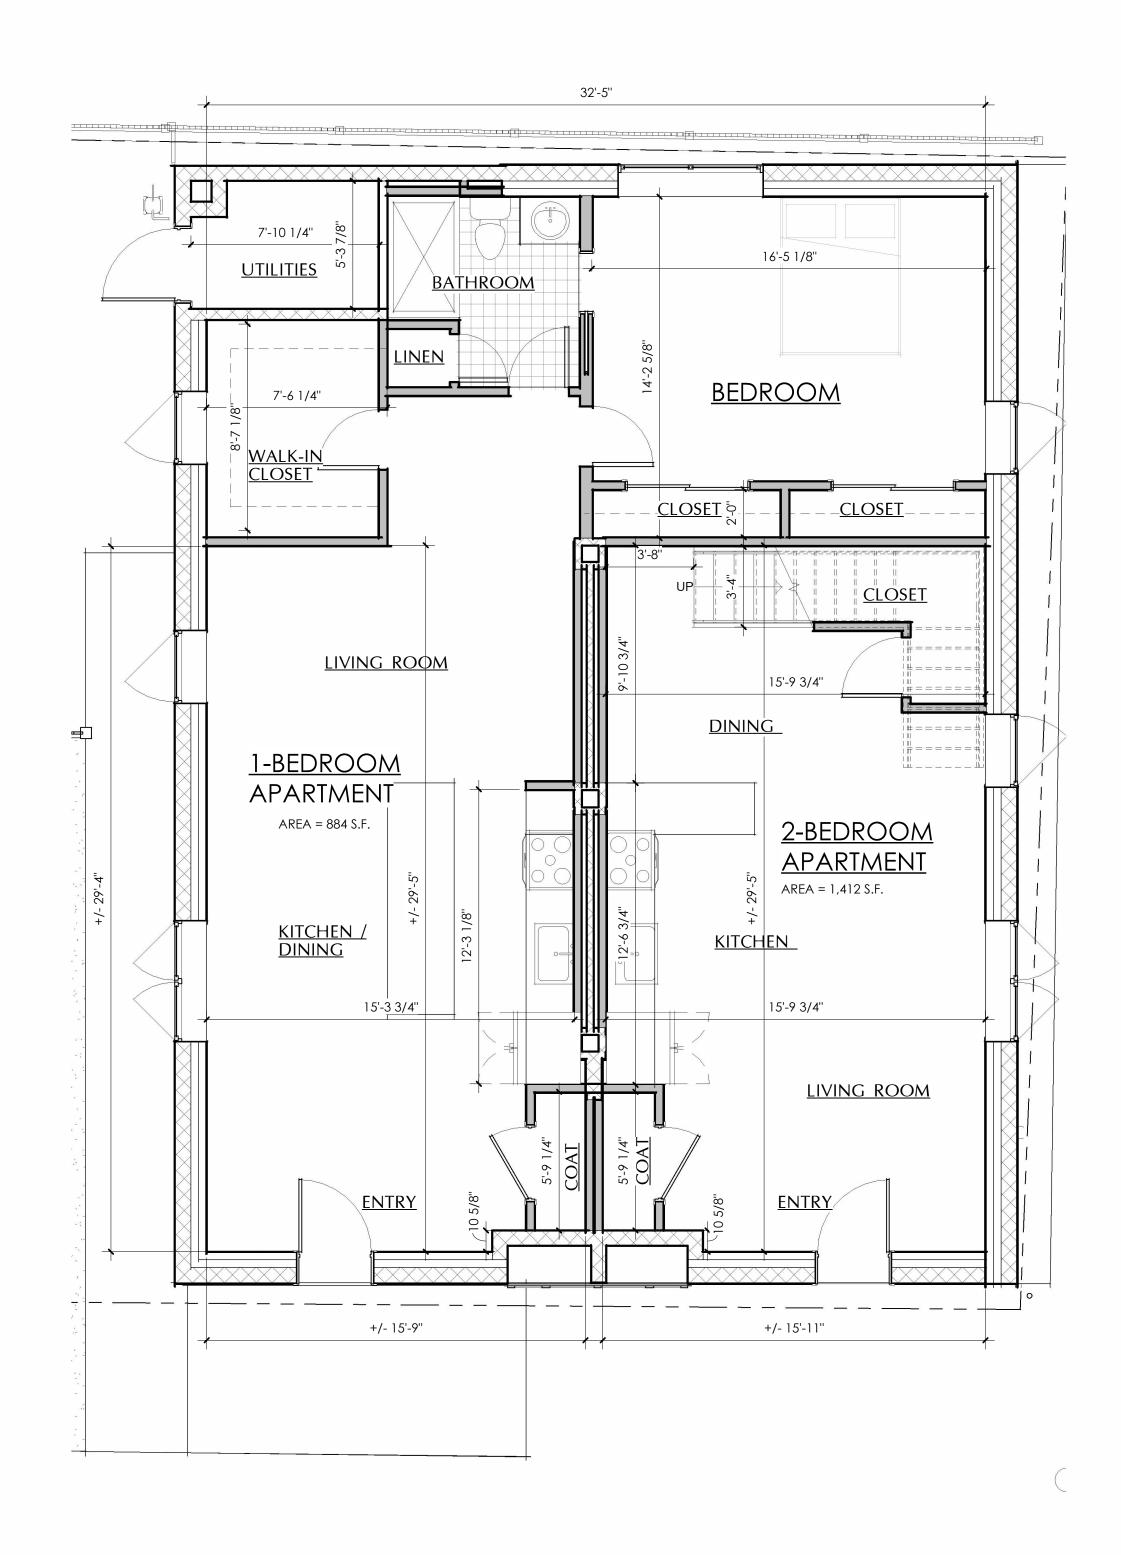

PROPOSED 1ST FLOOR PLAN

7A1.1 1/4" = 1'-0"

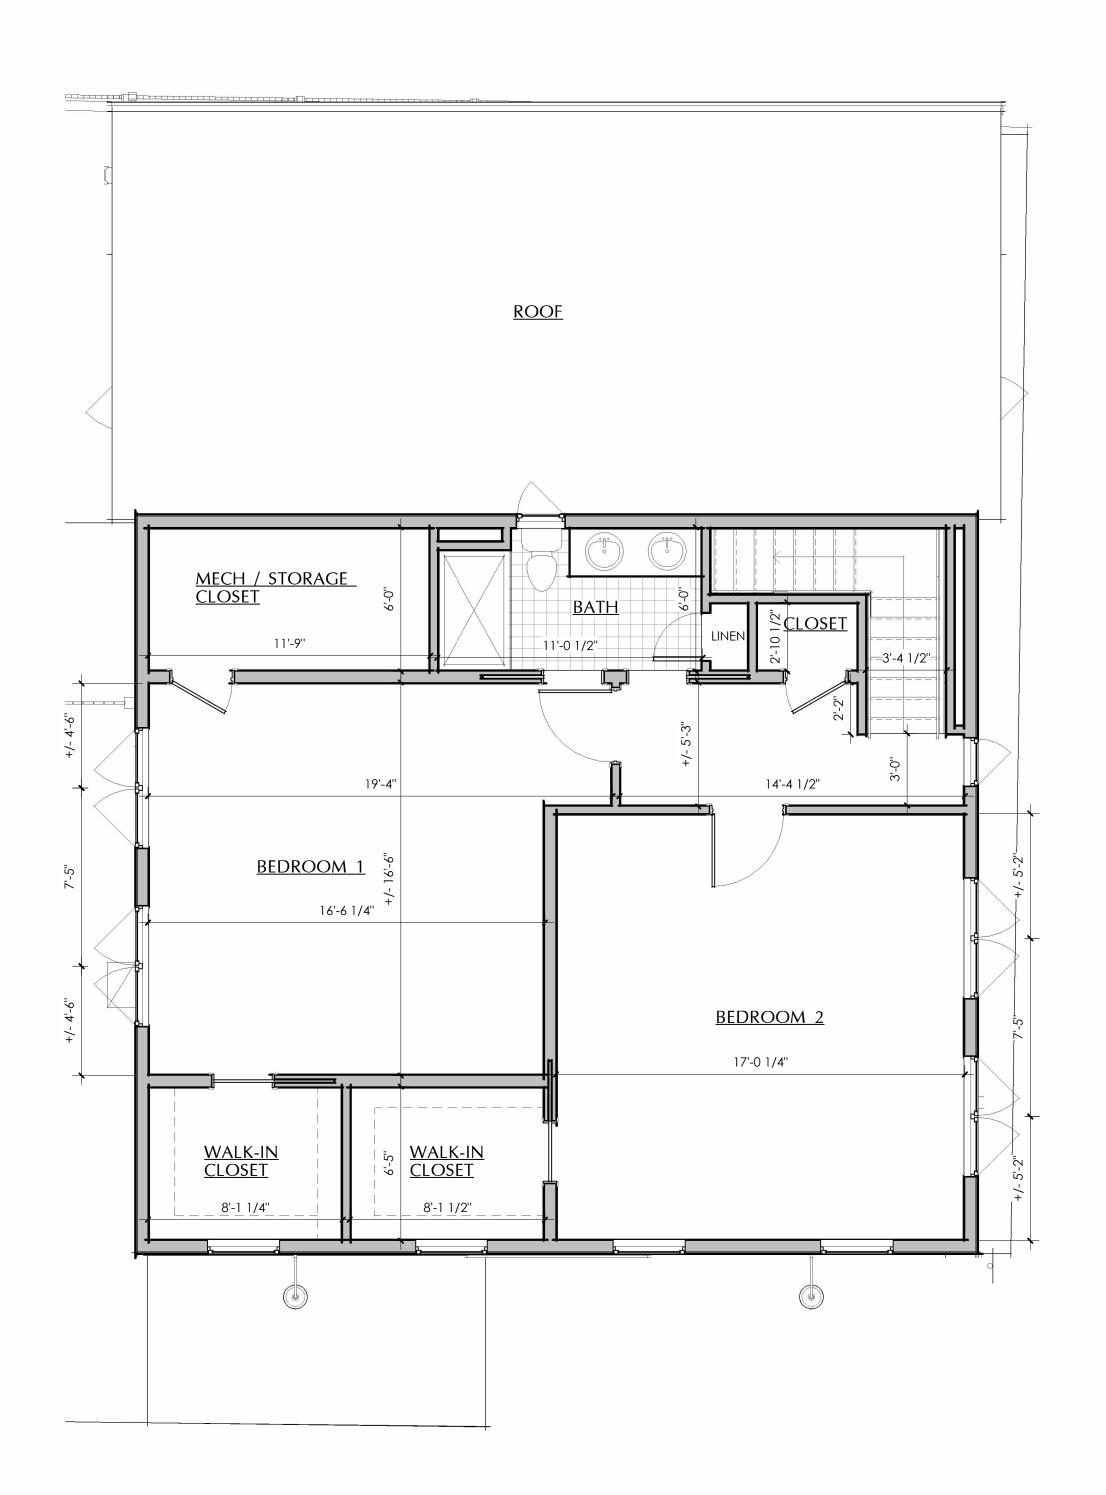

PROPOSED 2ND FLOOR PLAN 7A1.1 1/4" = 1'-0"

OWNED'C	CERTIFICATION OF CONTRACT
OWNERS	CERTIFICATION

WE, _____ THE UNDERSIGNED OWNER OF THE PROPERTY SHOWN HEREON, HEREBY CERTIFY THAT WE ARE FAMILIAR WITH THIS MAP, ITS CONTENTS AND DETAILS AND HEREBY AGREE TO THE TERMS AND CONDITIONS EXPRESSED HEREON.

OWNER'S NAME/ADDRESS DATE

VILLAGE OF FISHKILL PLANNING BOARD


APPROVED BY RESOLUTION OF THE PLANNING BOARD OF THE VILLAGE OF FISHKILL, NEW YORK ON THE _____ DAY OF _____ 20___, SUBJECT TO ALL REQUIREMENTS AND CONDITIONS OF SAID RESOLUTION. ANY CHANGES, ERASURES, MODIFICATIONS, OR REVISIONS OF THIS SITE PLAN AS APPROVED, SHALL VOID THIS APPROVAL.

PLANNING BOARD CHAIRPERSON


DATE

PROJECT PHASE:

(C) COPYRIGHT 2017 WHALEN ARCHITECTURE, PLLC		1		\ > -		1141 ROUTE 55, SUITE A, LAG	(845) 337-4331		
		DATE	9/4/25						
		BY	AA						
	REVISIONS / ISSUE DATES	DESCRIPTION	ISSUED TO PLANNING BOARD						
	REVISION	NO.							
CONSTRUCTION WITHOUT THE SEAL AND SIGNATURE OF THE ARCHITECT OF RECORD	PROJECT NAME:	Repovetions to:	Nellovations to.	IDD Properties	urch St	Fishkill, NY 12524		DRAWING TITLE:	FROPOSED FLOOR FLANS
NSTRUCTION WITH	1	WN BY	/:		SHI	EET:)F 1	<u> </u>	

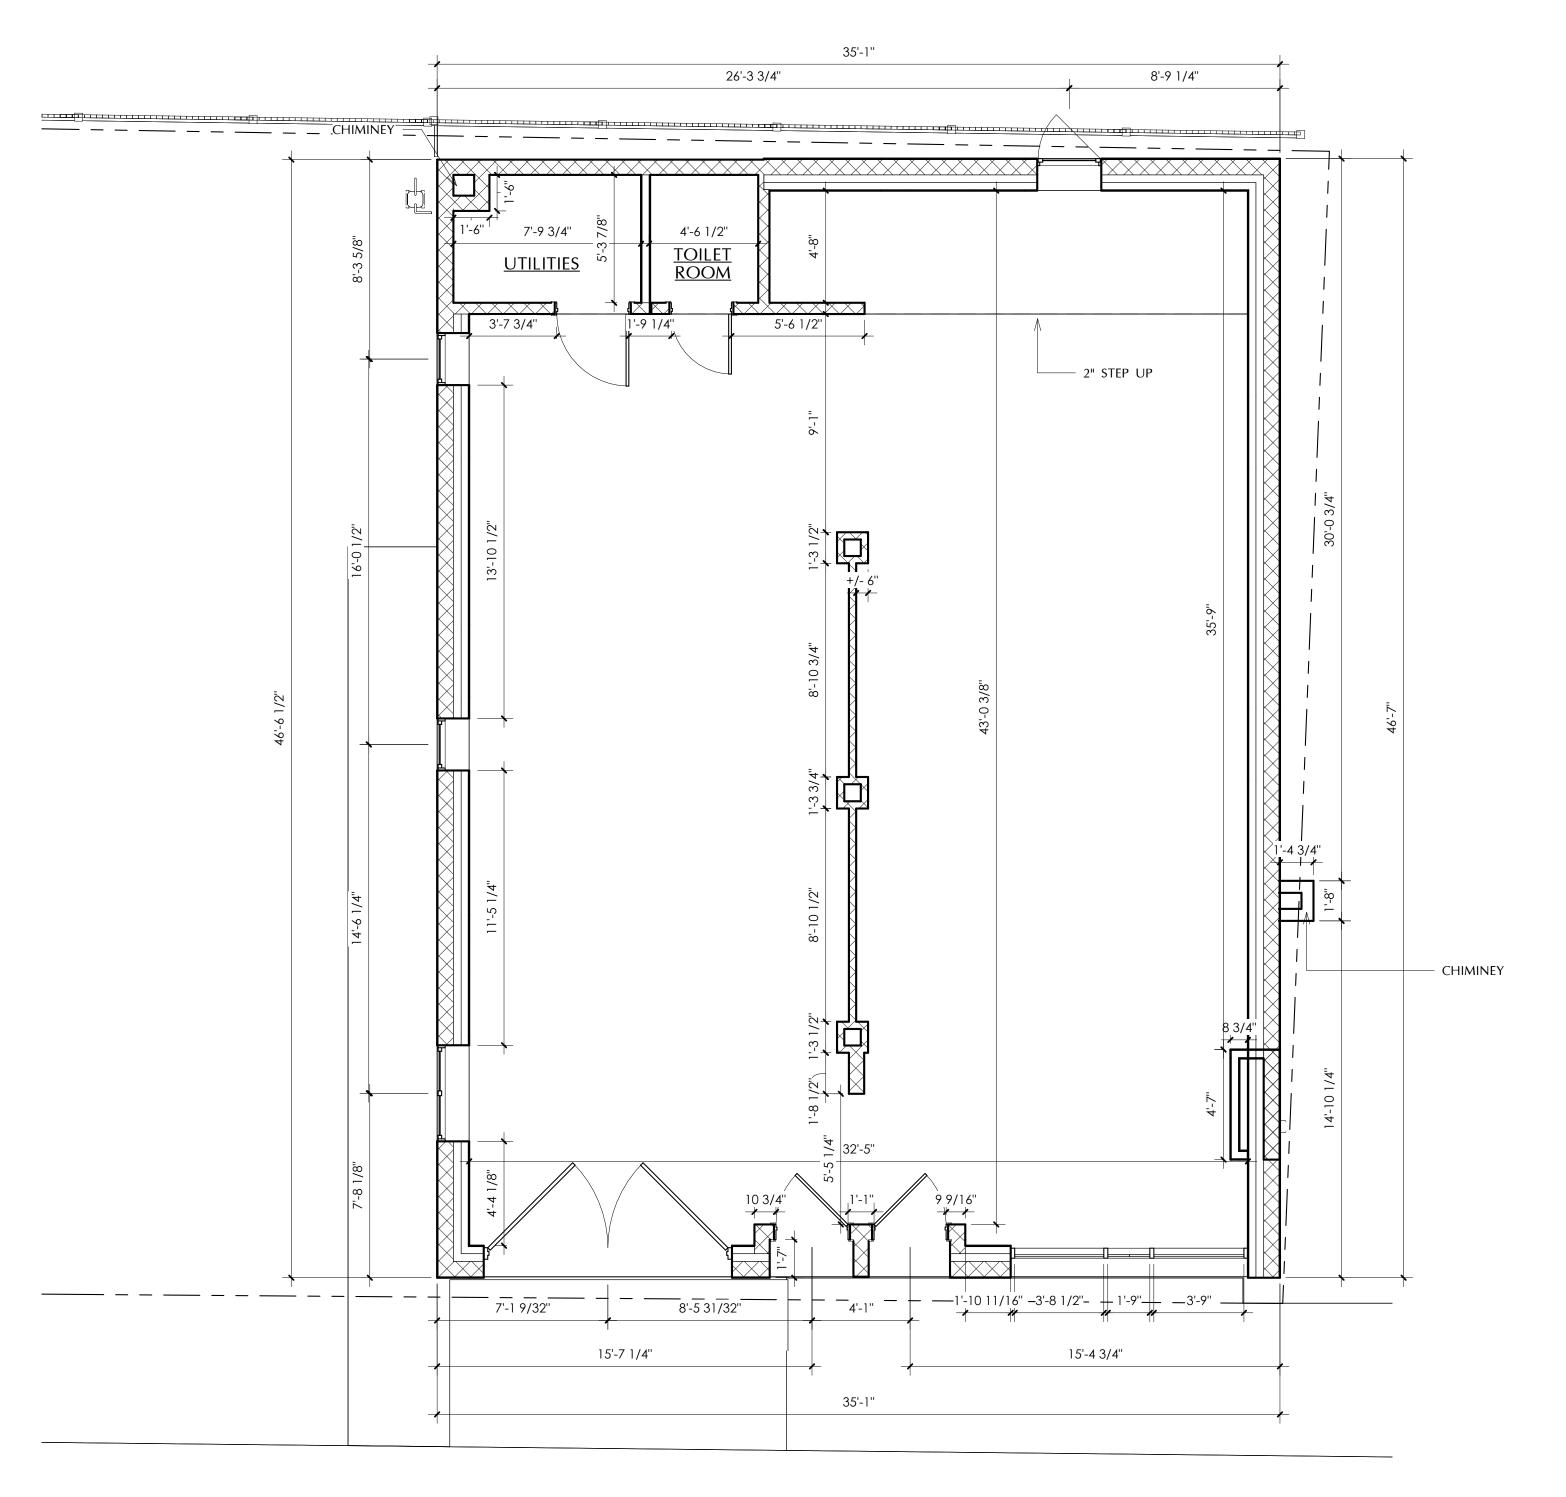

1 EXISTING 1ST FLOOR PLAN 8A1.2 1/4" = 1'-0"

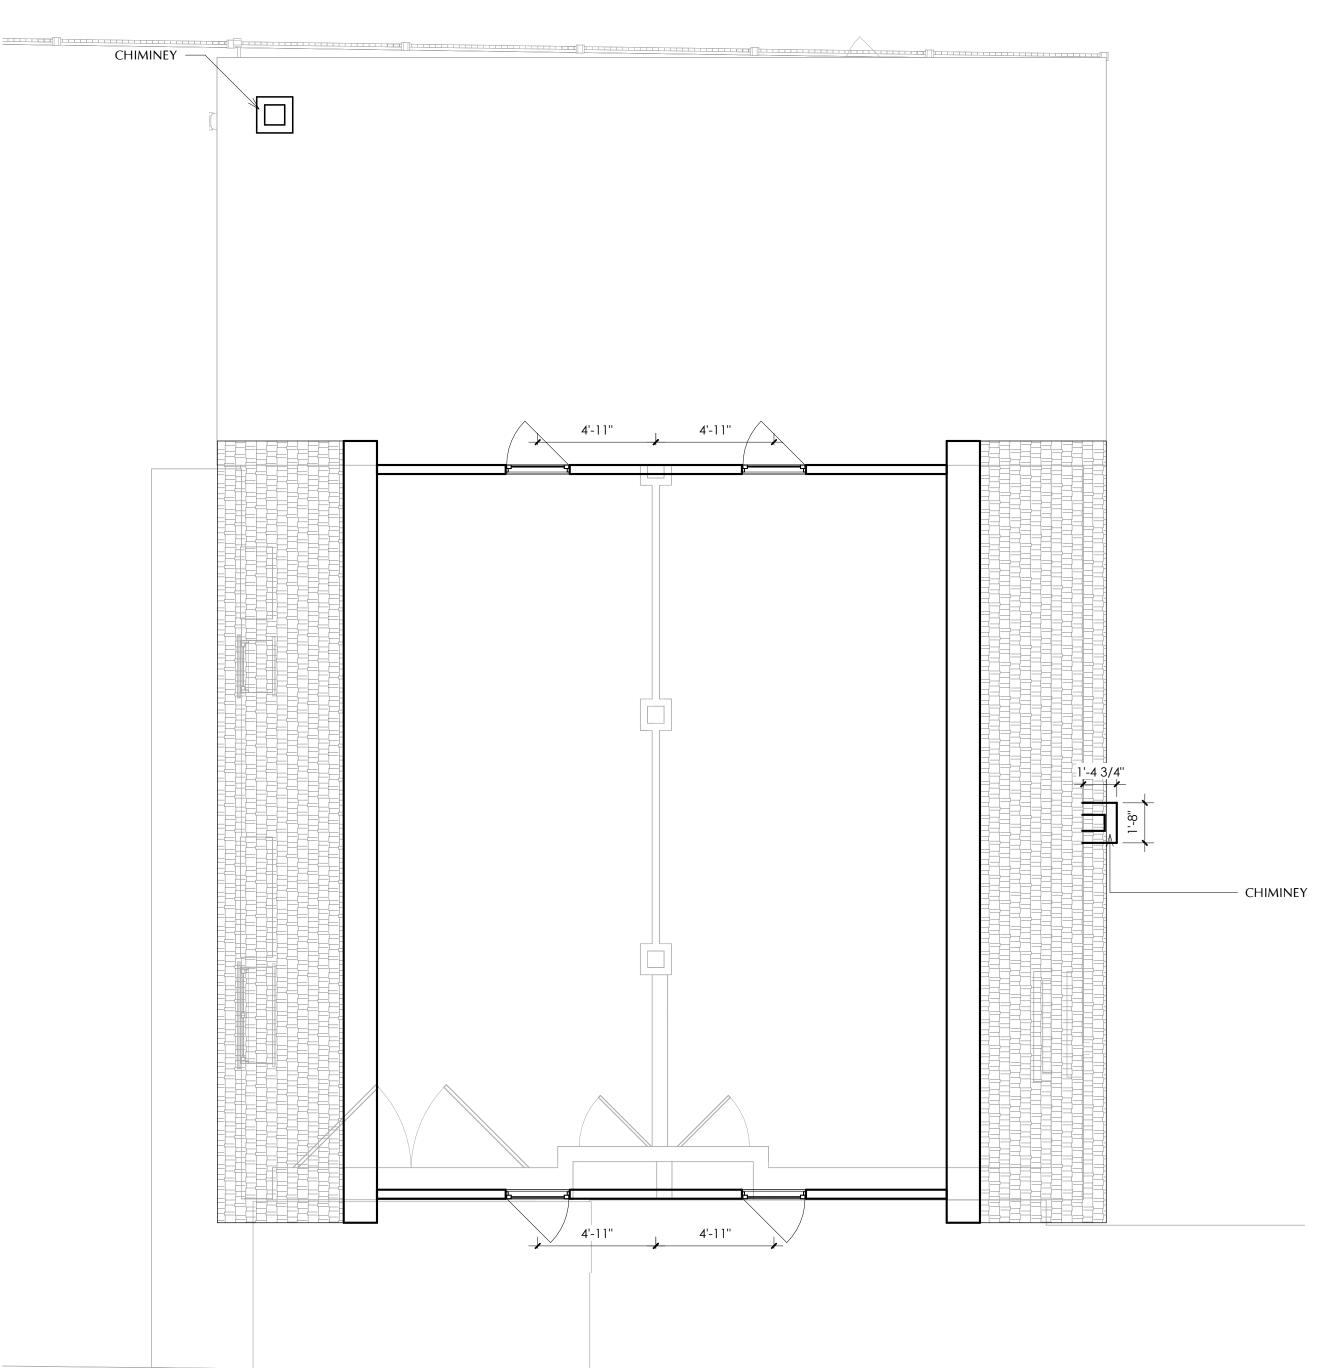

² EXISTING ATTIC PLAN 8A1.2 1/4" = 1'-0"

OWNER'S CERTIFICATION

WE, ______ THE UNDERSIGNED OWNER OF THE PROPERTY SHOWN HEREON, HEREBY CERTIFY THAT WE ARE FAMILIAR WITH THIS MAP, ITS CONTENTS AND DETAILS AND HEREBY AGREE TO THE TERMS AND CONDITIONS EXPRESSED HEREON.

OWNER'S NAME/ADDRESS

DATE

VILLAGE OF FISHKILL PLANNING BOARD


APPROVED BY RESOLUTION OF THE PLANNING BOARD OF THE VILLAGE OF FISHKILL, NEW YORK ON THE _____ DAY OF _____ 20___, SUBJECT TO ALL REQUIREMENTS AND CONDITIONS OF SAID RESOLUTION. ANY CHANGES, ERASURES, MODIFICATIONS, OR REVISIONS OF THIS SITE PLAN AS APPROVED, SHALL VOID THIS APPROVAL.

PLANNING BOARD CHAIRPERSON DATE

	PROJECT NAME:	Renovations to:	LDD Properties	19 Chirch Ctroot	lo Ciluicii Sileel	Fishkill, NY 12524			
THESE DRAWINGS ARE INSUFFICIENT FOR CONSTRUCTION WITHOUT THE SEAL AND SIGNATURE OF THE ARCHITECT OF RECORD								DRAWING TITLE:	
	DRAWN SW	I BY:			SH	HEET:) OF	11	
	DATE:			1	SC	CALE:			

AWN BY:	SHEET:
W	8 OF 11
E:	SCALE:
4/25	1/4" = 1'-0"
RAWING NO:	

PROJECT PHASE:

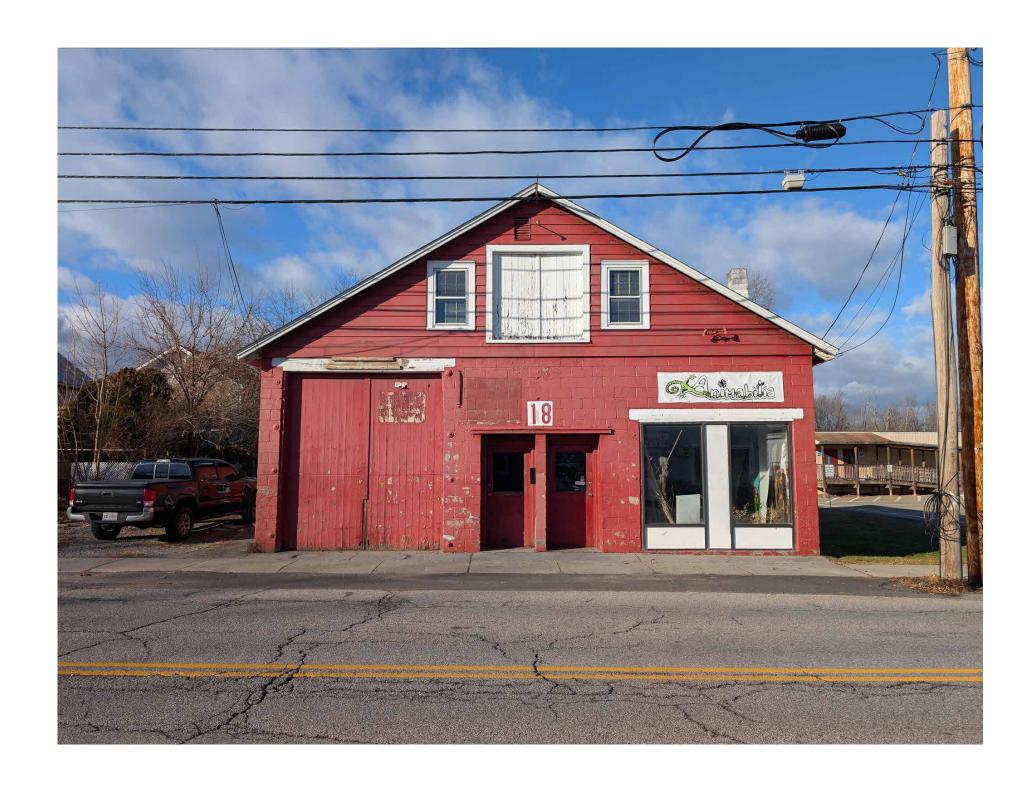

1 EXISTING FRONT PHOTO 9EP1.0 NO SCALE



3 EXISTING LEFT PHOTO
9EP1.0 NO SCALE



² EXISTING RIGHT PHOTO



4 EXISTING BACK PHOTO 9EP1.0 NO SCALE

OWNER'S CERTIFICATION

WE, _____ THE UNDERSIGNED OWNER OF THE PROPERTY SHOWN HEREON, HEREBY CERTIFY THAT WE ARE FAMILIAR WITH THIS MAP, ITS CONTENTS AND DETAILS AND HEREBY AGREE TO THE TERMS AND CONDITIONS EXPRESSED HEREON.

OWNER'S NAME/ADDRESS

DATE

VILLAGE OF FISHKILL PLANNING BOARD

APPROVED BY RESOLUTION OF THE PLANNING BOARD OF THE VILLAGE OF FISHKILL, NEW YORK ON THE _____ DAY OF _____ 20___, SUBJECT TO ALL REQUIREMENTS AND CONDITIONS OF SAID RESOLUTION. ANY CHANGES, ERASURES, MODIFICATIONS, OR REVISIONS OF THIS SITE PLAN AS APPROVED, SHALL VOID THIS APPROVAL.

PLANNING BOARD CHAIRPERSON

WHALEN
ARCHITECTURE
1141 ROUTE 55, SUITE A, LAGRANGEVILLE, NY 12540
(845) 337-4331 WHALENARCHITECTURE.COM

٠ ١							
		DATE	9/4/25				
		ВУ	YY				
	REVISIONS / ISSUE DATES	NO. DESCRIPTION	ISSUED TO PLANNING BOARD				

D Properties Church Street (ill, NY 12524

Renovations t
LDD Prop
18 Church St

DRAWN BY:
SW

DATE:
9/4/25

SHEET:
9 OF 11

SCALE:
1/4" = 1'-0"

DRAWING NO:

9EP1.0

PROJECT PHASE:

DATE